

CHARLES M. ARLINGHAUS Commissioner

STATE of NEW HAMPSHIRE DEPARTMENT of ADMINISTRATIVE SERVICES DIVISION of PUBLIC WORKS - DESIGN & CONSTRUCTION

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ADDENDUM NUMBER 01

FOR

NEW LEGISLATIVE PARKING GARAGE

33 CAPITOL STREET

CONCORD

DEPARTMENT OF ADMINISTRATIVE SERVICES

DIVISION OF PUBLIC WORKS PROJECT NUMBER 81284

CONTRACT B

APRIL 11, 2024

DOCUMENT 00911

ADDENDUM NUMBER 01

TO: ALL CONTRACT BIDDERS OF RECORD

This Addendum forms a part of the Contract Documents and modifies the Bidding Documents dated March 21, 2024, with amendments and additions noted below.

Acknowledge receipt of this Addendum in the space provided in the Proposal Form. Failure to do so may disqualify the Bidder.

This addendum format uses "Q" to represent questions submitted by participating bidders and "A" to represent answers to the questions. Questions and answers are listed in outline format below.

This Addendum consists of 7 pages and the following Drawings:

No	Drawing Title	Revised Issue Date
A0.1	DRAWING LIST	4/11/24
C1.01	EXISTING CONDITIONS &	4/11/24
	DEMOLITION PLAN	
C1.02	EXISTING UNDERGROUND UTILITY	4/11/24
	PLAN	
C2.01	PROPOSED SITE PLAN	4/11/24
C2.10	CIVIL WALL PENETRATION PLAN	4/11/24
LA3.0	PLANTING PLAN	4/11/24
LA4.0	SITE ELEVATIONS	4/11/24
LA4.1	SITE ELEVATIONS	4/11/24
LA5.1	RAMP DETAILS	4/11/24
S-101	FOUNDATION PLAN	4/11/24
S-113	ENLARGED FOUNDATION PLANS	4/11/24
S-114	ELEVATOR PIT SECTIONS	4/11/24
S-201	GROUND FLOOR FRAMING PLAN	4/11/24
ST-300	ENLARGED PARKING ACCESS AND	4/11/24
	REVENUE CONTROL PLANS	
A9.3	INTERIOR DETAILS	4/11/24
E4.0	ELECTRICAL PROPOSED SYSTEMS	4/11/24
	PLAN – GROUND FLOOR	
SE1.0	SITE ELECTRICAL PLAN	4/11/24

BIDDERS QUESTIONS

- 1. Q: Please provide bid form.
 - A: Please contact NHDOT Contracts.
- 2. Q: Please provide Bid Bond Form.
 - A: Please contact NHDOT Contracts.
- 3. Q: Please provide General and Supplemental Conditions:

- A: Provided in the project manual.
- 4. Q: Please provide sample contract.
 - A: Please contact NHDOT Contracts.
- 5. Q: Will bid results be shared immediately during a Teams / Zoom meeting.
 - A: Please contact NHDOT Contracts.
- 6. Q: Please confirm where addenda will be posted.
 - A: Addenda will be posted by DOT Contracts.
- 7. Q: What are the funding sources of this project?
 - A: State Funds
- 8. Q: Do guidelines for American Iron/Steel (AIS) or Build America Buy America (BABA) apply?
 - A: BABA does not apply. See Specification Section 01 300 Article 1.5 for steel fabrication requirements.
- 9. Q: Do prevailing wage rates/Davis Bacon Rates apply?
 - A: No.
- 10. Q: Are there any Minority/disadvantaged participation goals? If so, please clarify.
 - A: No.
- 11. Q: Reference Section 00250, Special Requirements. Section states, "The Contractor shall comply with all applicable NH Governor Emergency Orders related to the COVID-19 pandemic. The Contractor is encouraged to adhere to all current State and Federal guidelines related to the prevention of the spread of coronavirus." Please provide copy of current State and Federal guidelines.
 - A: The bidder is responsible to be aware of the requirements indicated in Section 00250 SPECIAL REQUIREMENTS
- 12. Q: Is there an Environmental Phase I and Phase II Study?
 - A: No
- 13. Q: C1.02 has stubbed Sewer/Sanitary on Green, School and North State Streets and nothing on Capital Street. P1.0 shows a 10" Sewer and 10" Sanitary leaving the garage onto Capital St. Please advise were the Sewer/Sanitary are to be connected.
 - A: Please see the Proposed Utility Plan, Sheet C2.08, for storm and sanitary utilities
- 14. Q: Please provide the manufacturer for the Bronze State Seal.
 - A: Spec Section 05 7311 indicates basis of design.

- 15. Q: Are Canadian supplier/installers allowed to bid this project?
 - A: Yes.
- 16. Q: Please clarify the Fancoil listed in equipment schedules. Model information indicates cooling only. The OD unit listed is a Hyper Heat HP unit. Which direction are we going with this?
 - A: The fancoil listed in the equipment schedules (Hyper Heat HP unit) is part of a heat pump system with indoor fan coil unit and outdoor heat pump unit, designed to operate to provide both heating and cooling to the space as required. The heating and cooling performances are indicated.
- 17. Q: Also, the equipment listed may be affected by the R410A refrigerant phaseout. Should we be quoting the equipment in the new A2L refrigerant variants.
 - A: The currently enforced New Hampshire Building Code references the 2018 ICC codes and has not been updated or amended to allow A2L refrigerants at this time. Please quote the R410A refrigerant.
- 18. Q: There is no minimum R in the specification I found for the Stair Tower Roof. Should we assume R=30?
 - A: Tapered insulation at the stair tower roof is for drainage only. The stair tower is unheated and does not require a minimum insulation value. The design intent is for minimum tapered insulation thickness at the drain and the thickness required at the roof edge to maintain 1/4" per foot drainage to the roof drains. Drawings imply approximately 6" at the perimeter.
- 19. Q: Are overhead lines on the south and west side of the site being relocated as part of the building demo project?
 - A: No.
- 20. Q: Please specify how much fill will need to be imported once the existing building has been removed.
 - A: Drawing C1.01 indicates the anticipated site conditions after the DOJ building is removed. Bidders will use this information to quantify fill required in conjunction with other grading plans and fill required under the ground floor ramp.
- 21. Q: Regarding Spec Section 01 4110 Vibration Monitoring, which calls for a Plan, surveys, reports, etc. Please confirm if the engineer to draft the Vibration Monitoring Plan has to be licensed in the state of NH, or if he can be licensed in the state of New Jersey or Rhode Island.
 - A: Qualifications requirements for the engineer acting as the Vibration Consultant are specified in Section 01 4110 Vibration Monitoring, paragraph 1.02.C. and reference the 2016 NH DOT Standard Specifications, paragraphs 203.3.3.1 and 203.3.3.2. They are reproduced below. They do not specify that the consultant be licensed in NH, although that is preferred. Code reference:

- 3.3.1 Seismologist or Blasting Consultant. The Contractor shall retain a seismologist or blasting consultant to monitor, record, analyze, and report the seismic vibrations being caused by blasting activities. The name and résumé of qualifications of the seismologist or blasting consultant shall be submitted to the Engineer for approval no later than the preblast meeting. No drilling or blasting shall take place until such approval is given. The seismologist or blasting consultant shall not be an employee of the Contractor, Subcontractor, explosives manufacturer, or explosives distributor.
- 3.3.2 Seismologist or Blasting Consultant qualifications. The seismologist or blasting consultant shall be experienced in the subject of vibrations emanating from blasting activities. The seismologist or blasting consultant shall be qualified to thoroughly analyze seismic parameters of the energy source, the energy transmission path, the recording site, and the ground motion spectra. The minimum qualifying requirement to perform the necessary documentation and analysis is a Bachelor of Science degree with accredited course work in at least three of the following disciplines: Seismology, Geophysics, Geophysical Data Processing, Geomechanics, Geophysical Engineering, Vibration Engineering, Soil and/or Rock Mechanics, Foundation and/or Explosive Engineering, Advanced Calculus, and Time-Series (Fourier) Analysis.

CHANGES TO THE SPECIFICATIONS

- 22. Section 08 7100 Door Hardware
 - A: MODIFY Door hardware Set 'D':
 - 1. Revise Exit Device line to read: "(1) Exit Device- room side (active leaf)."
 - 2. Revise functional description, second to last sentence to read: "Exiting from the room always possible through active leaf by pushing exit device."
- 23. Section 08 4413 Glazed Aluminum Curtain Walls
 - A: Revise the Curtainwall Specification Section 08 4413, paragraph 2.03 Components: Delete paragraph 2.03.C.
- 24. Section 221005 Plumbing Piping
 - A: Modify Section 2.02 (Sanitary and Sewer and Vent Piping) and Section 2.06 (Storm Drainage Piping) to add PVC piping as acceptable below-grade material for sanitary sewer and vent piping. PVC piping must be properly scheduled for the below grade use and be appropriate for ground and building loads above it.
 - B: All above grade piping called to be cast iron shall remain as cast iron.
- 25. Section 32 1440 Stone Paving, Steps, and Walls
 - A: Revise 2.1 B-1 c: REMOVE "Color: Williams Blue Sky"; ADD: "Color: Kittledge"
 - B: Revise 2.1 B-1e: Remove "Manufacturer: Williams Stone Co" and address; ADD: "Manufacturer: Granites of America, 15 Branch Pike, Smithfield, RI 029170".

CHANGES TO THE DRAWINGS

- 26. DRAWING A2.0 GROUND FLOOR PLAN
 - a. ADD: The following notes at Door 106:
 - i. "Provide 12"x 12" white plastic sign with black letters mounted on door 106 indicating "EMERGENCY EXIT ONLY"
 - ii. "Provide 12"x 12" white plastic sign with black letters mounted on door 106 indicating "OPEN CAREFULLY"
- 27. DRAWING A4.4 ENLARGED ELEVATIONS

- A: **Q:** Drawing A4.3 calls for an Aluminum Valance on the GFRC, Drawing A4.4 calls for Cast Iron. Which are we to provide?
 - i. A: Aluminum shall be provided. MODIFY Drawing #1: "Cast Iron Valence" shall be "Aluminum Valence" to coordinate with material called for in Spec Section 05 7311.

28. DRAWING A9.3 INTERIOR DETAILS Detail #5

- a. MODIFY: The dimension from the walking surface to the bottom of the lower guard rail to be 3 ³/₄" instead of the 6" shown.
- 29. REPLACE the drawings issued with the bid set with the following drawings attached to this addendum:
 - A: DRAWING A0.1 DRAWING LIST
 - B: DRAWING C1.01 EXISTING CONDITIONS & DEMOLITION PLAN
 - C: DRAWING C1.02 EXISTING UNDERGROUND UTILITY PLAN
 - D: DRAWING C2.01 PROPOSED SITE PLAN
 - E: DRAWING C2.10 CIVIL WALL PENETRATION PLAN
 - F: DRAWING LA3.0 PLANTING PLAN
 - G: DRAWING LA4.0 SITE ELEVATIONS
 - H: DRAWING LA4.1 SITE ELEVATIONS
 - I: DRAWING LA5.1 RAMP DETAILS
 - J: DRAWING S-101 FOUNDATION PLAN
 - K: DRAWING S-102 ENLARGED FOUNDATION PLANS
 - L: DRAWING S-113 FOUNDATION ELEVATOINS
 - M: DRAWING S-114 ELEVATOR PIT SECTIONS
 - N: DRAWING S-201 GROUND FLOOR PLAN
 - O: DRAWING ST-300 ENLARGED PARKING ACCESS AND REVENUE CONTROL PLANS
 - P: DRAWING E4.0 ELECTRICAL PROPOSED SYSTEMS PLAN GROUND FLOOR
 - Q: DRAWING SE1.0 SITE ELECTRICAL PLAN

MISC. ITEMS

30. See attached Pre-Bid Conference sign-in sheet, dated 04-09-24.

Michelle L. Quliano
Michelle Juliano, P.E. Deputy Director

Division of Public Works Design and Construction

END OF DOCUMENT

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DRAWINGS:


GENERAL		SHEET ISSUE DATE REVISION DA
A0.0 A0.1	NH COVER DRAWING LIST	03/08/24
A0.1 A0.2	GENERAL NOTES AND ABBREVIATIONS	03/08/24
A0.3	EXISTING AND PROPOSED	03/08/24
A0.4	PERSPECTIVE VIEWS	03/08/24
LIFE SAFETY		
LIFE SAFETY LS-000	CODE SUMMARY SHEET	03/08/24
LS-001	HEIGHT & AREA SUMMARY	03/08/24
LS-002	FIRE SEPARATION DISTANCE	03/08/24
LS-101 LS-102	LIFE SAFETY PLAN - GROUND FLOOR LIFE SAFETY PLAN - SECOND FLOOR	03/08/24
LS-102 LS-103	LIFE SAFETY PLAN - SECOND FLOOR LIFE SAFETY PLAN - THIRD FLOOR	03/08/24
LS-104	LIFE SAFETY PLAN - FOURTH FLOOR	03/08/24
CIVIL		
C0.01	OVERALL SITE PLAN	03/08/24
C1.00	NOTES AND LEGEND	03/08/24
C1.01	EXISTING CONDITIONS & DEMOLITION PLAN	03/08/24
C1.02 C1.03	EXISTING UNDERGROUND UTILITY PLAN EXISTING TRAFFIC SIGNS	03/08/24
C2.00	SITE LAYOUT & CONTROL	03/08/24
C2.01	PROPOSED SITE PLAN	03/08/24
C2.03	GRADING PLAN NORTH-WEST	03/08/24
C2.04 C2.05	GRADING PLAN SOUTH WEST	03/08/24
C2.05 C2.06	GRADING PLAN SOUTH-WEST GRADING PLAN SOUTH-EAST	03/08/24
C2.07	ADA RAMP PLAN AND DETAIL	03/08/24
C2.08	PROPOSED UTILITY PLAN	03/08/24
C2.09	PROPOSED IRRIGATION PLAN	03/08/24
C2.10 C2.11	CIVIL WALL PENETRATION PLAN PAVEMENT MARKING PLAN	03/08/24
C2.11	PROPOSED TRAFFIC SIGNS	03/08/24
C3.01	STORMWATER PROFILES	03/08/24
C3.02	STORMWATER PROFILES	03/08/24
C3.03	SEWER PROFILE EROSION PREVENTION AND SEDIMENT CONTROL PLAN	03/08/24 03/08/24
C4.01 C5.01	CIVIL DETAILS	03/08/24
C5.02	CIVIL DETAILS CIVIL DETAILS	03/08/24
C5.03	CIVIL DETAILS	03/08/24
C5.04	CIVIL DETAILS	03/08/24
C5.05 C5.06	CIVIL DETAILS CIVIL DETAILS	03/08/24 03/08/24
C5.06 C5.07	CIVIL DETAILS CIVIL DETAILS	03/08/24
C5.08	IRRIGATION DETAILS	03/08/24
C5.09	IRRIGATION DETAILS	03/08/24
C5.10 T1.01	IRRIGATION NOTES TRAFFIC CONTROL NOTES	03/08/24
T1.01	TRAFFIC CONTROL NOTES TRAFFIC CONTROL SCHOOL STREET	03/08/24
T1.03	TRAFFIC CONTROL GREEN STREET	03/08/24
T1.04 T1.05	TRAFFIC CONTROL CAPITOL STREET TRAFFIC CONTROL N. STATE STREET	03/08/24 03/08/24
_A0.1 _A1.0	TREE PROTECTION PLAN & NOTES HARDSCAPE & MATERIALS PLAN	03/08/24 03/08/24
LA2.0	LAYOUT PLAN PAVING ENLARGEMENTS	03/08/24
LA2.1 LA3.0	PLANTING PLAN	03/08/24
LA3.1	PLANTING ENLARGEMENTS	03/08/24
LA4.0	SITE ELEVATIONS	03/08/24
LA4.1	SITE ELEVATIONS	03/08/24
LA5.0 LA5.1	SITE DETAILS RAMP DETAILS	03/08/24
LA5.1 LA5.2	SITE DETAILS	03/08/24
LA5.3	PLANTING DETAILS	03/08/24
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S-001	ABBREVIATIONS, NOTATIONS & SYMBOLS	03/08/24
S-002	GENERAL STRUTURAL NOTES	03/08/24
S-003 S-004	GENERAL STRUTURAL NOTES GENERAL CONSTRUCTION NOTES & DESIGN CRITERIA	03/08/24
S-004 S-005	TYPICAL SLAB-ON-GRADE DETAILS	03/08/24
S-006	TYPICAL FOUNDATION DETAILS	03/08/24
S-007	TYPICAL FOUNDATION DETAILS	03/08/24
S-008 S-101	GENERAL CMU DETAILS FOUNDATION PLAN	03/08/24
S-101 S-102	ENLARGED FOUNDATION PLANS	03/08/24
S-103	ENLARGED UNDER-RAMP ROOM DETAILS	03/08/24
S-111	FOUNDATION SECTIONS & DETAILS	03/08/24
S-112 S-113	FOUNDATION SECTIONS & DETAILS FOUNDATION ELEVATIONS	03/08/24
S-113 S-114	ELEVATIONS ELEVATIONS	03/08/24
S-115	ENLARGED PEDESTRIAN RAMP DETAILS	03/08/24
S-201	GROUND FLOOR FRAMING PLAN	03/08/24
S-202 S-203	SECOND FLOOR FRAMING PLAN THIRD FLOOR FRAMING PLAN	03/08/24
S-203 S-204	FOURTH FLOOR FRAMING PLAN	03/08/24
S-301	TYPICAL PRECAST DETAILS	03/08/24
S-302	TYPICAL PRECAST DETAILS II	03/08/24
S-303 S-304	TYPICAL PRECAST DETAILS III TYPICAL PRECAST DETAILS IV	03/08/24
S-304 S-305	TYPICAL PRECAST DETAILS IV TYPICAL STRUCTURAL DETAILS I	03/08/24
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S-401	STRUCTURAL BUILDING SECTIONS	03/08/24
S-402 S-403	ROOF EGRESS STEEL FRAMING BOLLARD PLAN	03/08/24
S-403 ST-101	GROUND FLOOR STRIPING PLAN	03/08/24
ST-102	SECOND FLOOR STRIPING PLAN	03/08/24
ST-103	THIRD FLOOR STRIPING PLAN	03/08/24
ST-104 ST-105	FOURTH FLOOR STRIPING PLAN	03/08/24
ST-105 ST-201	TYPICAL STRIPING DETAILS GROUND FLOOR WAYFINDING SIGNAGE PLAN	03/08/24
ST-201 ST-202	SECOND FLOOR WAYFINDING SIGNAGE PLAN	03/08/24
ST-203	THIRD FLOOR WAYFINDING SIGNAGE PLAN	03/08/24
ST-204	FOURTH FLOOR WAYFINDING SIGNAGE PLAN	03/08/24
	TVDICAL WAVEINDING CICNAGE DETAILS	03/00/34
ST-204 ST-205 ST-206	TYPICAL WAYFINDING SIGNAGE DETAILS TYPICAL SIGNAGE MOUNTING	03/08/24 03/08/24
T-205	TYPICAL WAYFINDING SIGNAGE DETAILS TYPICAL SIGNAGE MOUNTING ELARGED PARKING ACCESS & REVENUE CONTROL PLANS	03/08/24 03/08/24 03/08/24


ARCHITECTU A2.1	GROUND FLOOR PLAN	SHEET ISSUE DATE REVISION D 03/08/24
A2.2	LEVEL 2 PLAN	03/08/24
A2.3	LEVEL 3 PLAN	03/08/24
A2.4	LEVEL 4 PLAN	03/08/24
A2.5	ENLARGED ROOF PLANS	03/08/24
\3.1 \4.1	REFLECTED CEILING PLANS EXTERIOR ELEVATIONS	03/08/24 03/08/24
44.1 44.2	EXTERIOR ELEVATIONS	03/08/24
44.3	ENLARGED ELEVATIONS	03/08/24
\4.4	ENLARGED ELEVATIONS	03/08/24
44.5	ENLARGED ELEVATIONS	03/08/24
44.6	ENLARGED ELEVATIONS	03/08/24
A4.13	STAIR TOWER PANEL ELEVATIONS	03/08/24
44.14 45.1	PRECAST MOCK-UP BUILDING SECTIONS	03/08/24 03/08/24
45.2	BUILDING SECTIONS	03/08/24
A5.3	ENLARGED PLANS AT STAIR TOWER	03/08/24
A5.4	BUILDING SECTIONS AT STAIR TOWER	03/08/24
A5.5	BUILDING SECTIONS AT STAIR TOWER	03/08/24
A5.6	BUILDING SECTIONS AT STAIR TOWER	03/08/24
45.7 45.8	DETAILS OF STAIR TOWER GUARDRAILS DETAILS OF STAIR TOWER GUARDRAILS	03/08/24
A5.6 A5.9	DETAILS OF STAIR TOWER GUARDRAILS DETAILS OF STAIR TOWER GUARDRAILS	03/08/24
45.10	DETAILS OF STAIR TOWER GUARDRAILS	03/08/24
A5.11	FLOOR PLANS AND SECTION AT SOUTH-WEST EGRESS STAIR	03/08/24
A5.12	SECTIONS AT SOUTH WEST EGRESS STAIRS	03/08/24
A5.13	FLOOR PLANS AND SECTION AT SOUTH-EAST EGRESS STAIRS	03/08/24
A5.14	SECTIONS AT SOUTH-EAST EGRESS STAIRS	03/08/24
A6.0	GFRC & PRECAST CONCRETE DIAGRAM	03/08/24
46.1 46.2	WALL SECTIONS STAIR TOWER WALL SECTIONS	03/08/24 03/08/24
46.2 47.1	GFRC ENTABLATURE DETAILS	03/08/24
A7.2	GFRC PILASTER DETAILS	03/08/24
¥7.3	GFRC WATERTABLE DETAILS	03/08/24
\ 7.4	GFRC STAIR TOWER DETAILS	03/08/24
A7.5	GFRC STAIR TOWER DETAILS	03/08/24
\7.7 \7.0	ARCHITECTURAL METALS DETAILS	03/08/24
47.8 47.9	EXTERIOR DETAILS EXTERIOR DETAILS	03/08/24 03/08/24
47.9 48.1	INTERIOR ELEVATIONS	03/08/24
49.1	INTERIOR DETAILS TYPE 1 CONDUIT COVER	03/08/24
A9.2	INTERIOR DETAILS TYPE 2 CONDUIT COVER	03/08/24
\9.3	INTERIOR DETAILS	03/08/24
A10.1	CURTAIN WALL & STOREFRONT AND DOOR SCHEDULES	03/08/24
E2.1 E2.2 E2.3	ELECTRICAL PROPOSED POWER PLAN - SECOND FLOOR ELECTRICAL PROPOSED POWER PLAN - THIRD FLOOR ELECTRICAL PROPOSED POWER PLAN - FOURTH FLOOR	03/08/24 03/08/24 03/08/24
E3.0	ELECTRICAL PROPOSED LIGHTING PLAN - GROUND FLOOR	03/08/24
Ξ3.1	ELECTRICAL PROPOSED LIGHTING PLAN - SECOND FLOOR	03/08/24
E3.2	ELECTRICAL PROPOSED LIGHTING PLAN - THIRD FLOOR	03/08/24
E3.3 E4.0	ELECTRICAL PROPOSED LIGHTING PLAN - FOURTH FLOOR ELECTRICAL PROPOSED SYSTEMS PLAN - GROUND FLOOR	03/08/24 03/08/24
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<u>-4.1</u> <u>-4.2</u>	ELECTRICAL PROPOSED SYSTEMS PLAN - SECOND FEOOR	03/08/24
E 4.3	ELECTRICAL PROPOSED SYSTEMS PLAN - FOURTH FLOOR	03/08/24
E5.0	ELECTRICAL ONE LINE DIAGRAM AND PANEL SCHEDULES	03/08/24
E6.0	ELECTRICAL DETAILS	03/08/24
SE1.0	SITE ELECTRICAL PLAN	03/08/24
IGHTING		
_0.0	COVER SHEET	03/08/24
0.2	LIGHTING FIXTURE SCHEDULE	03/08/24
_0.3 _0.4	LIGHTING FIXTURE SCHEDULE NOTES SITE LIGHTING PHOTOMETRICS	03/08/24 03/08/24
_0.4 _1.0.	LANDSCAPE LIGHTING	03/08/24
_1.0. _1.1	LEVEL 1 LIGHTING	03/08/24
_2.1	LEVEL 2 LIGHTING	03/08/24
_3.1	LEVEL 3 LIGHTING	03/08/24
_4.1	LEVEL 4 LIGHTING	03/08/24
MECHANICAL M0.1	MECHANICAL LEGENDS, NOTES & ABREVIATIONS	03/08/24
мо. i M1.0	MECHANICAL LEGENDS, NOTES & ABREVIATIONS MECHANICAL FLOOR PLAN - LEVEL 1	03/08/24
ит.о И1.1	MECHANICAL FLOOR PLAN - LEVEL 2	03/08/24
M1.2	MECHANICAL FLOOR PLAN - LEVEL 3	03/08/24
M1.3	MECHANICAL FLOOR PLAN - LEVEL 4	03/08/24
M1.4	MECHANICAL ROOF PLAN	03/08/24
M6.0 M6.1	MECHANICAL DETAILS MECHANICAL SCHEDULES	03/08/24 03/08/24
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PLUMBING		
P0.1	PLUMBING LEGENDS, NOTES & ABREVIATIONS	03/08/24
P1.0	PLUMBING DRAINAGE PLAN - BELOW SLAB & LEVEL 1	03/08/24
P1.1	PLUMBING DRAINAGE PLANS - LEVEL 2 & 3	03/08/24
P1.2	PLUMBING DRAINAGE PLANS - LEVEL 4 & TOWER ROOF	03/08/24
P2.0	PLUMBING FLOOR PLAN - LEVEL 1	03/08/24 03/08/24
P2.1 P5.0	PLUMBING PART PLANS PLUMBING DETAILS & SCHEDULES	03/08/24
J.J	1 LOWIDING DETAILS & GOLILDOLLS	JUI
FIRE PROTEC	CTION	
-P1.0	GROUND LEVEL FIRE PROTECTION PLAN	03/08/24
	TYPICAL LEVELS 2 - 4 FIRE PROTECTION PLAN	03/08/24
FP1.1	TIPICAL LEVELS 2 - 4 FIRE PROTECTION PLAN	03/00/24

mDELEGATED DESIGN NOTE

architect/engineer:

The following project components are called out as Delegated Design elements and will be submitted with stamped drawings and calculations during shop drawings for review by the design 1. Ground Improvements (aggregate piers) 2. Precast concrete 3. GFRC 4. Guardrails and handrails 5. Glazed curtainwall

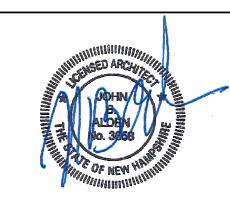

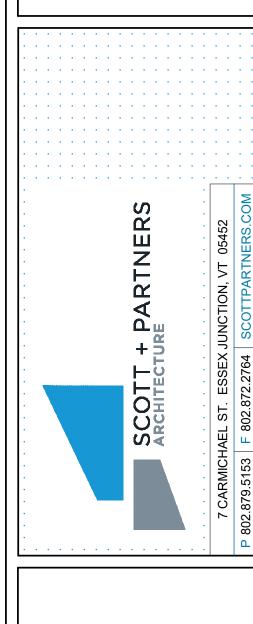

New Legislative | Garage

1" = 1'-0" scale: 16-1142 project no. JA / KT checked by: EK / TJN drawn by: proj. date: 4/11/24 sheet date: No Date Revisions

1 4/11/24 Addendum 1

DRAWING LIST


sheet no.


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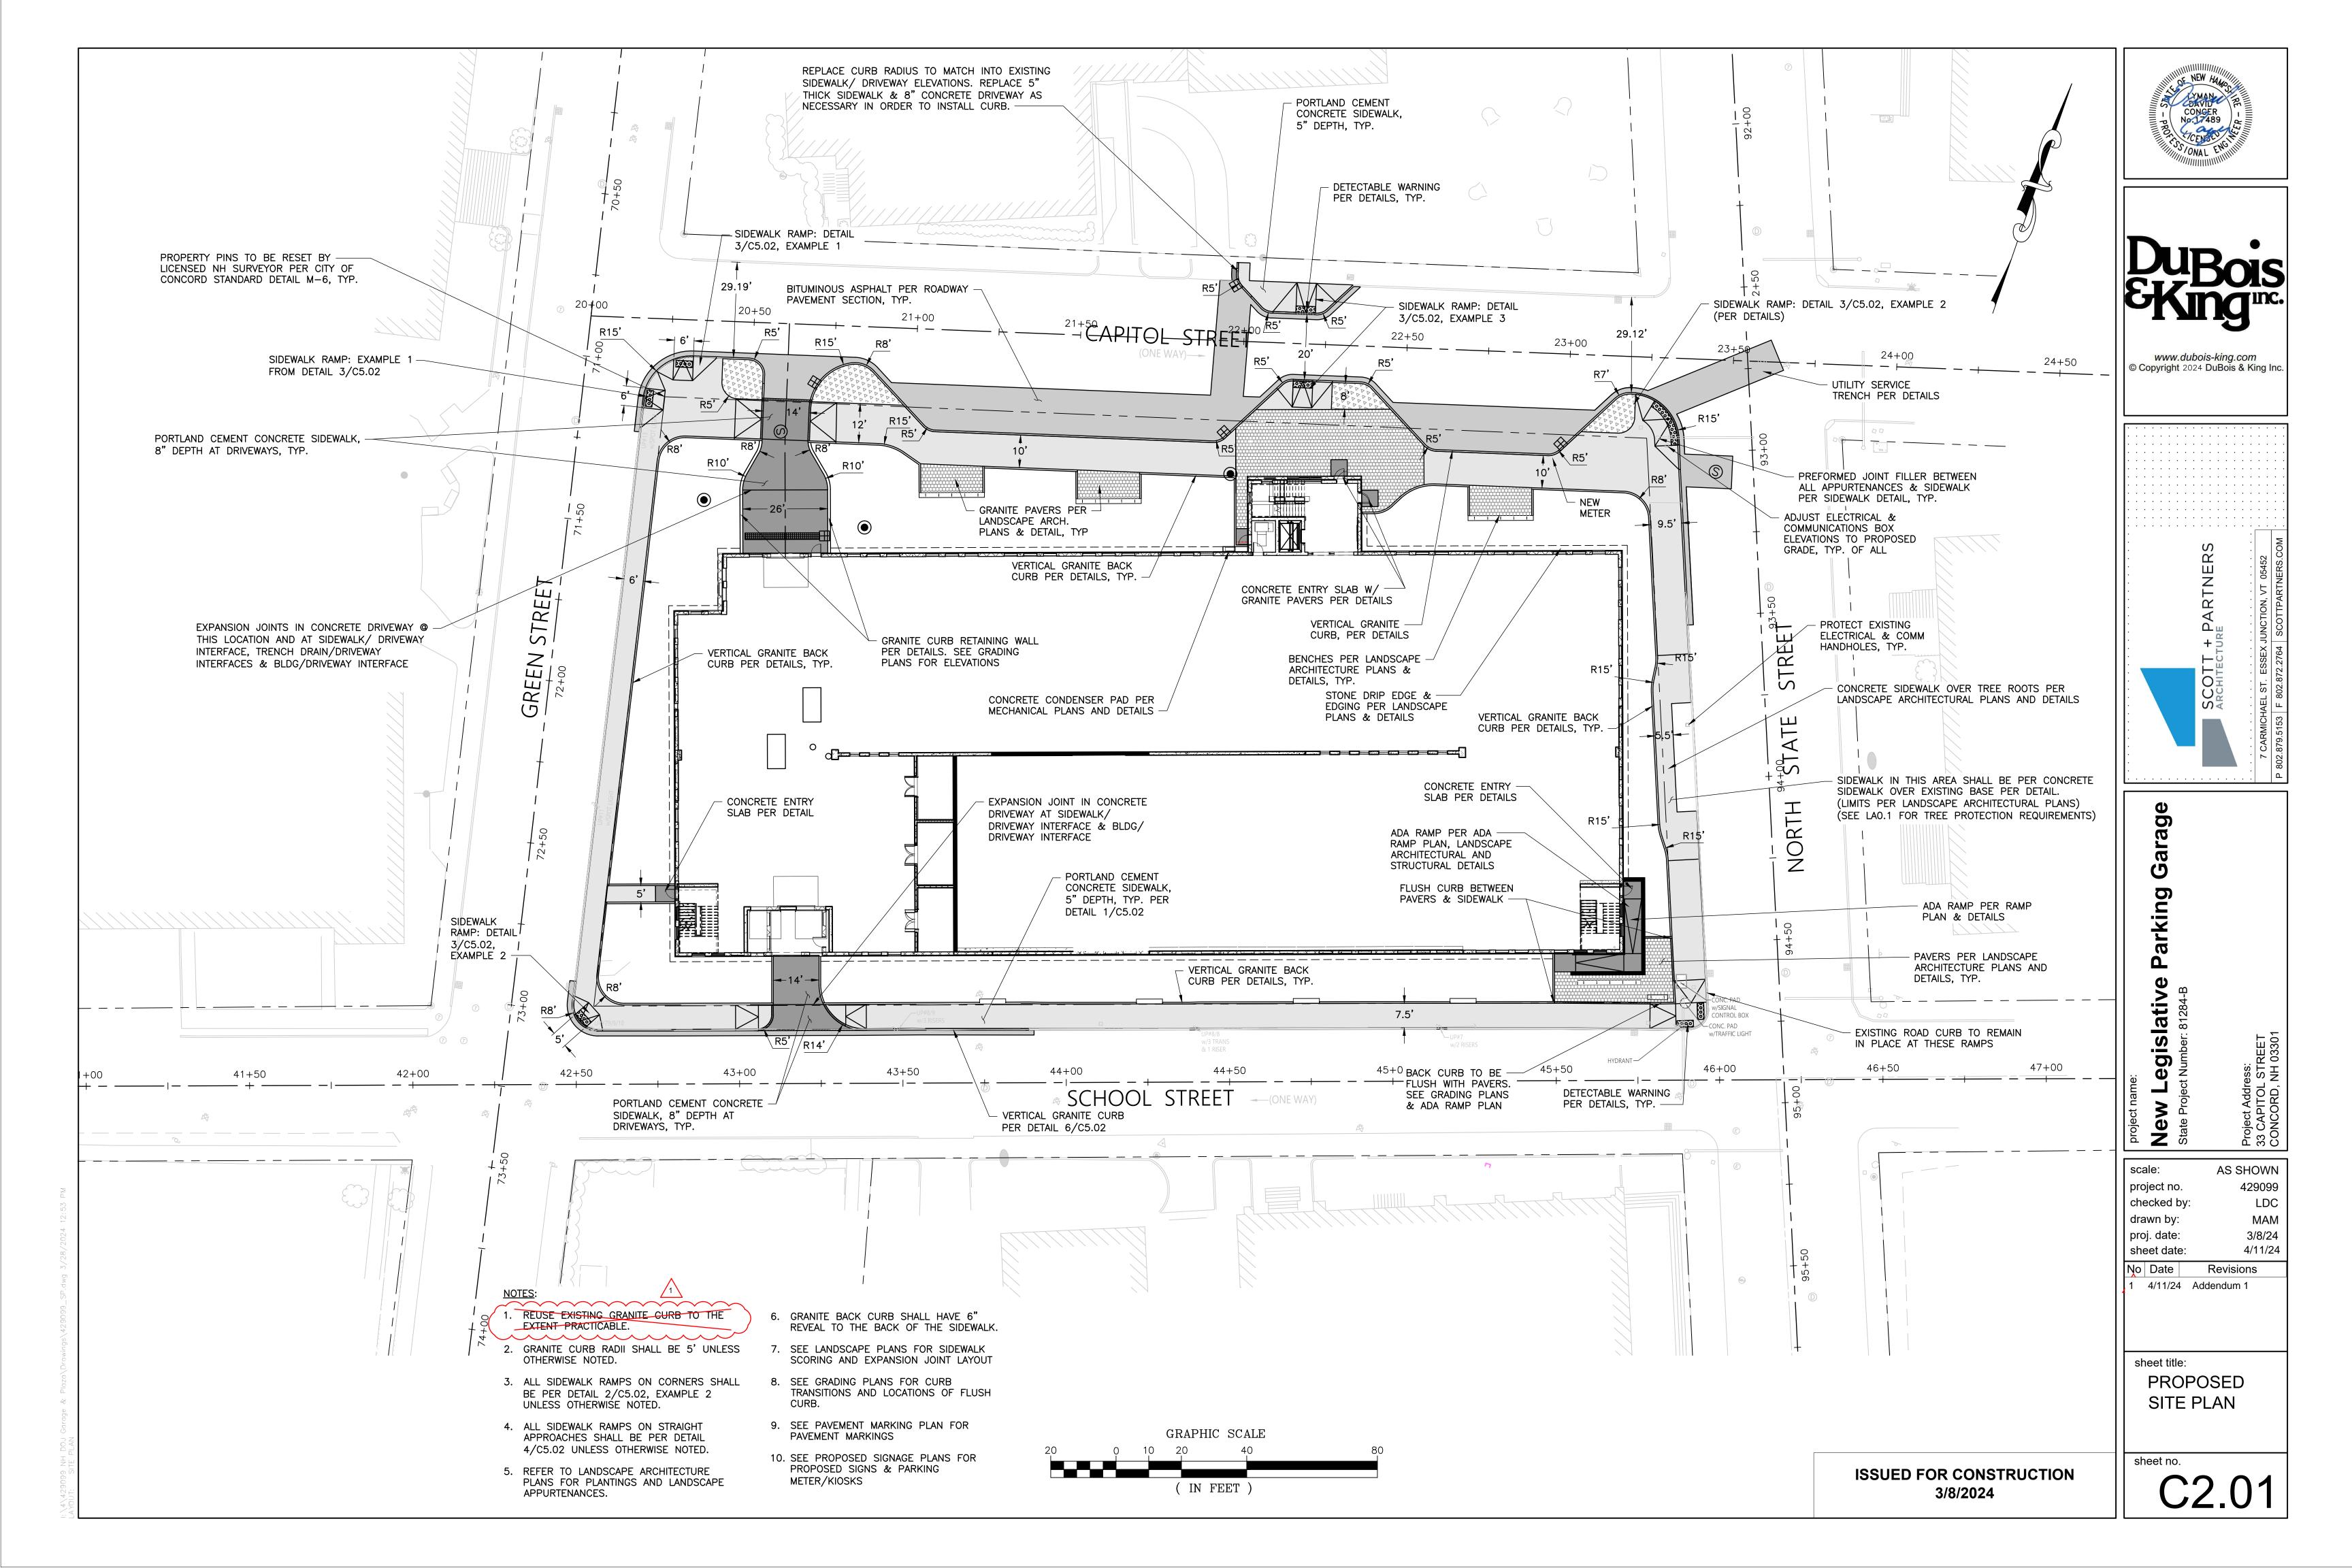
ALTERNATES


REFER TO S-201 FOR DEDUCT ALTERNATE #1 (ASPHALT GROUND FLOOR PAVING IN LIEU OF SLAB ON GRADE)

> ISSUED FOR CONSTRUCTION 3/8/24




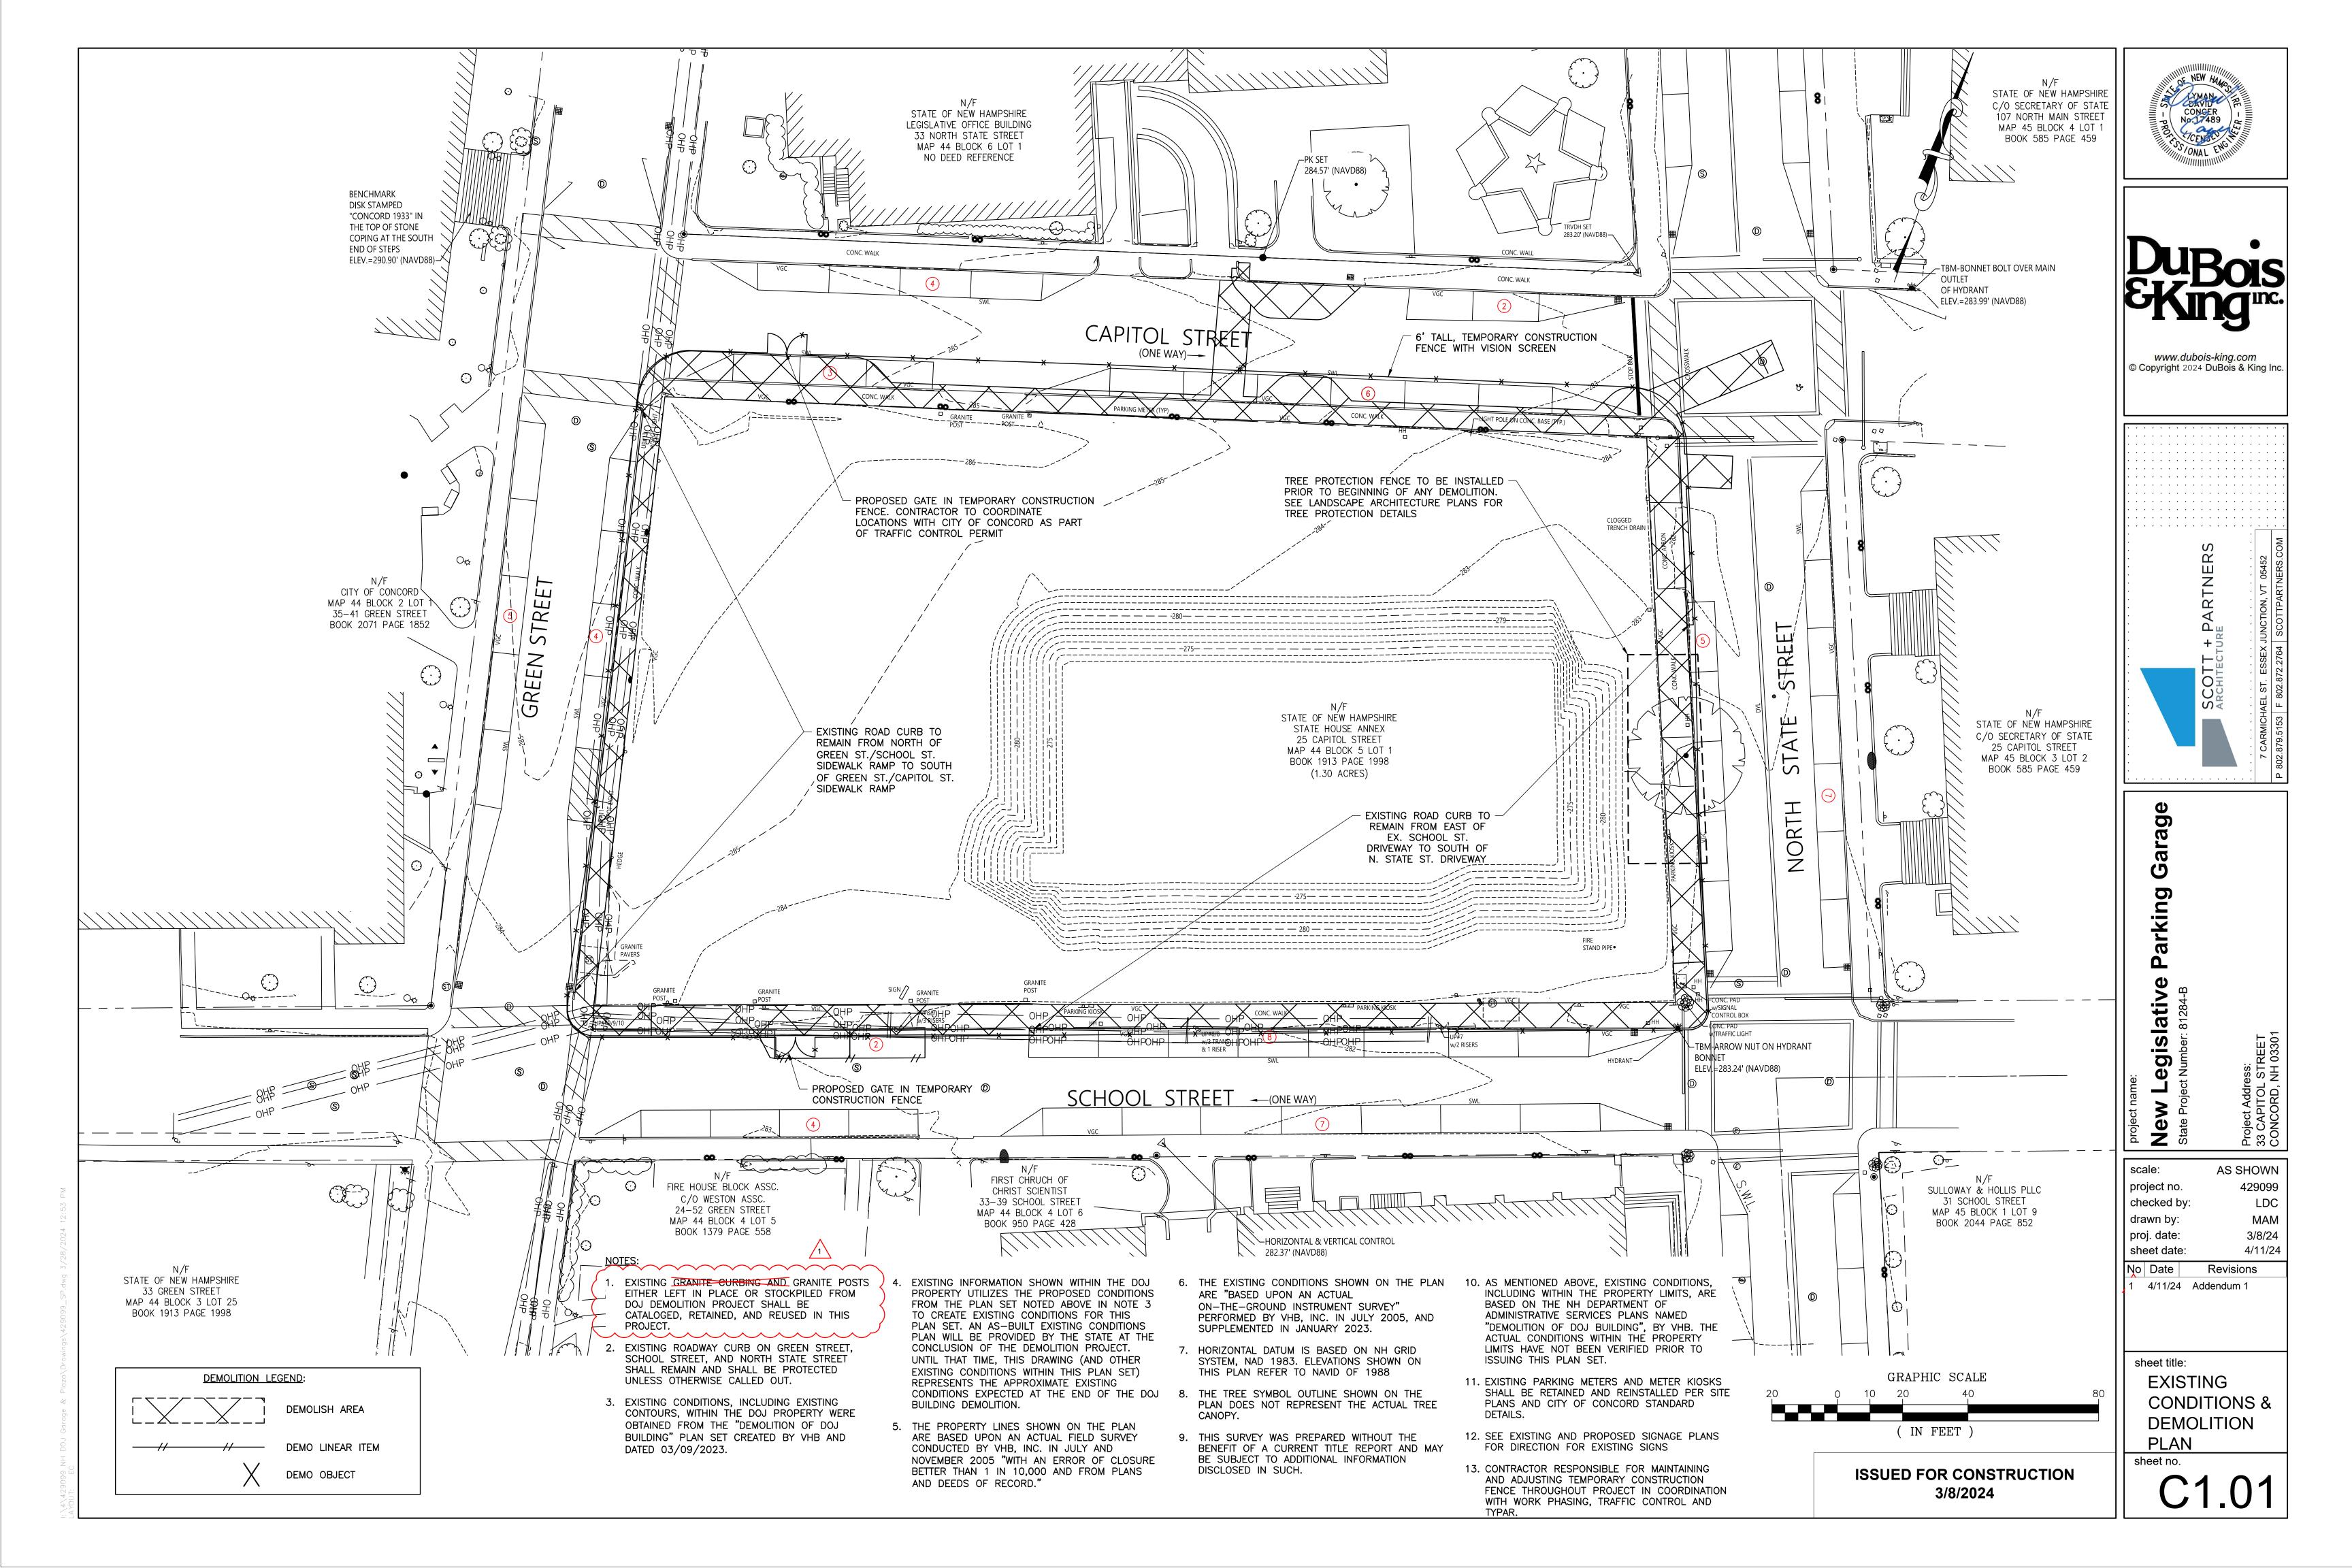

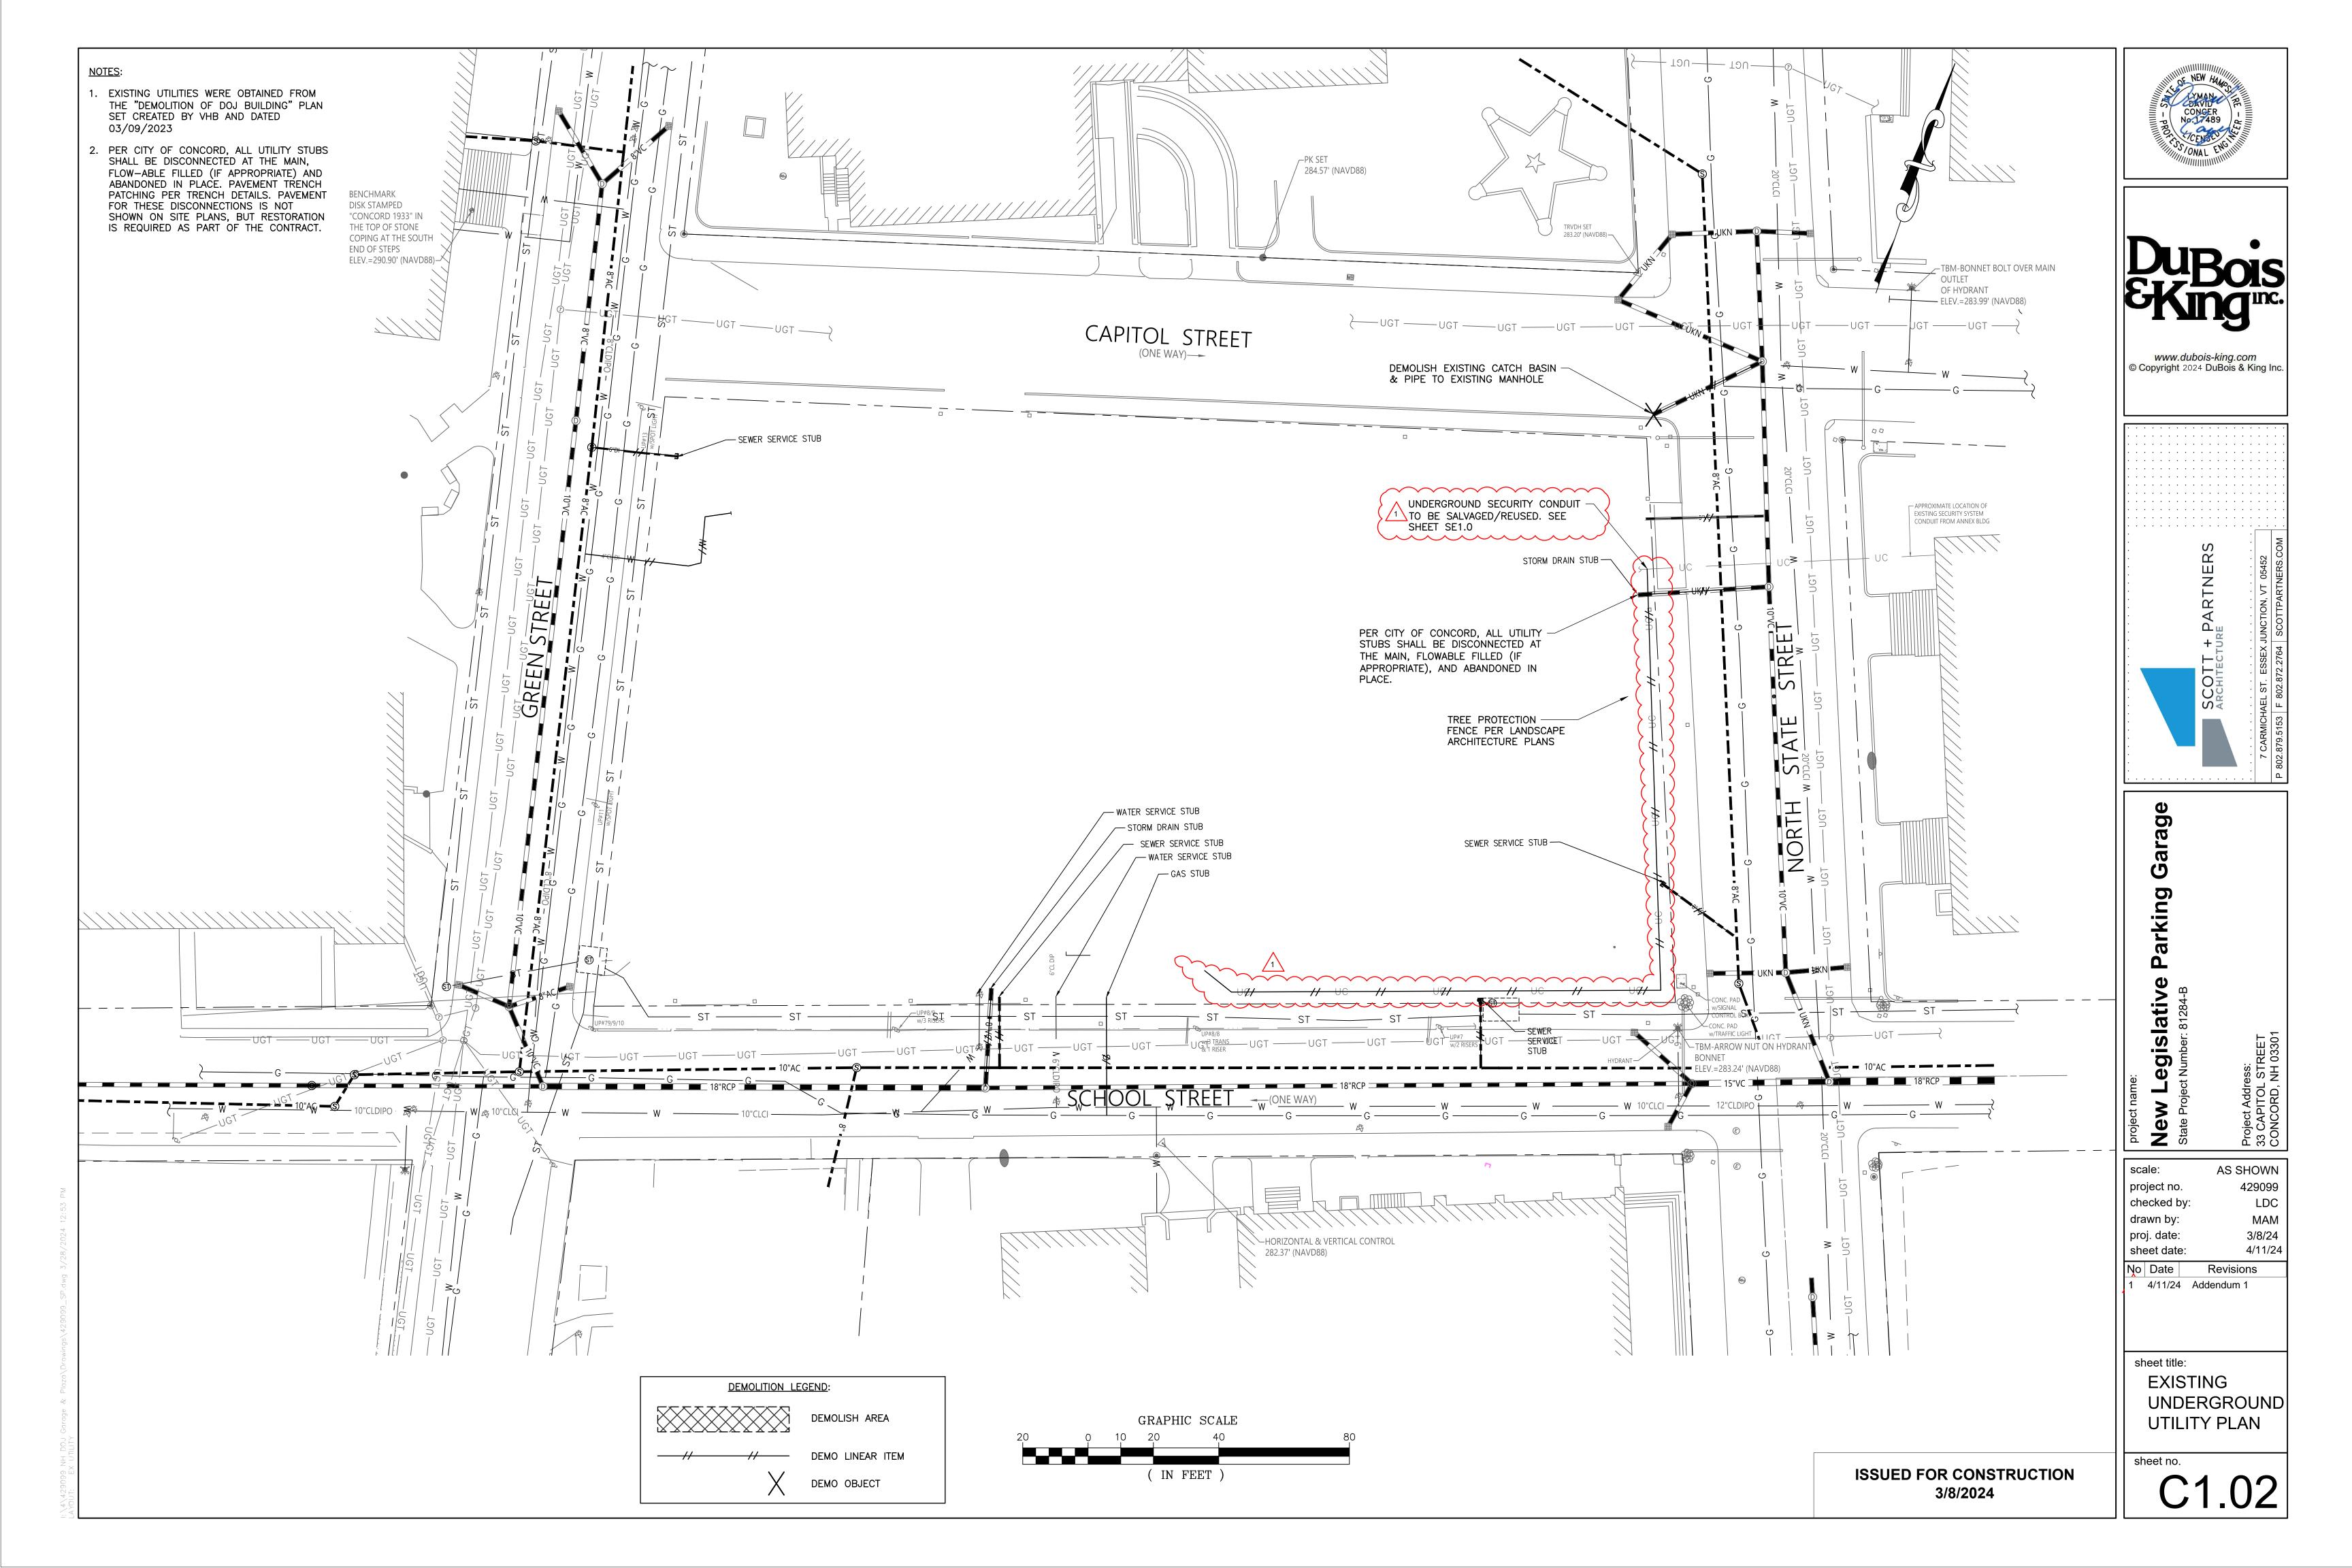

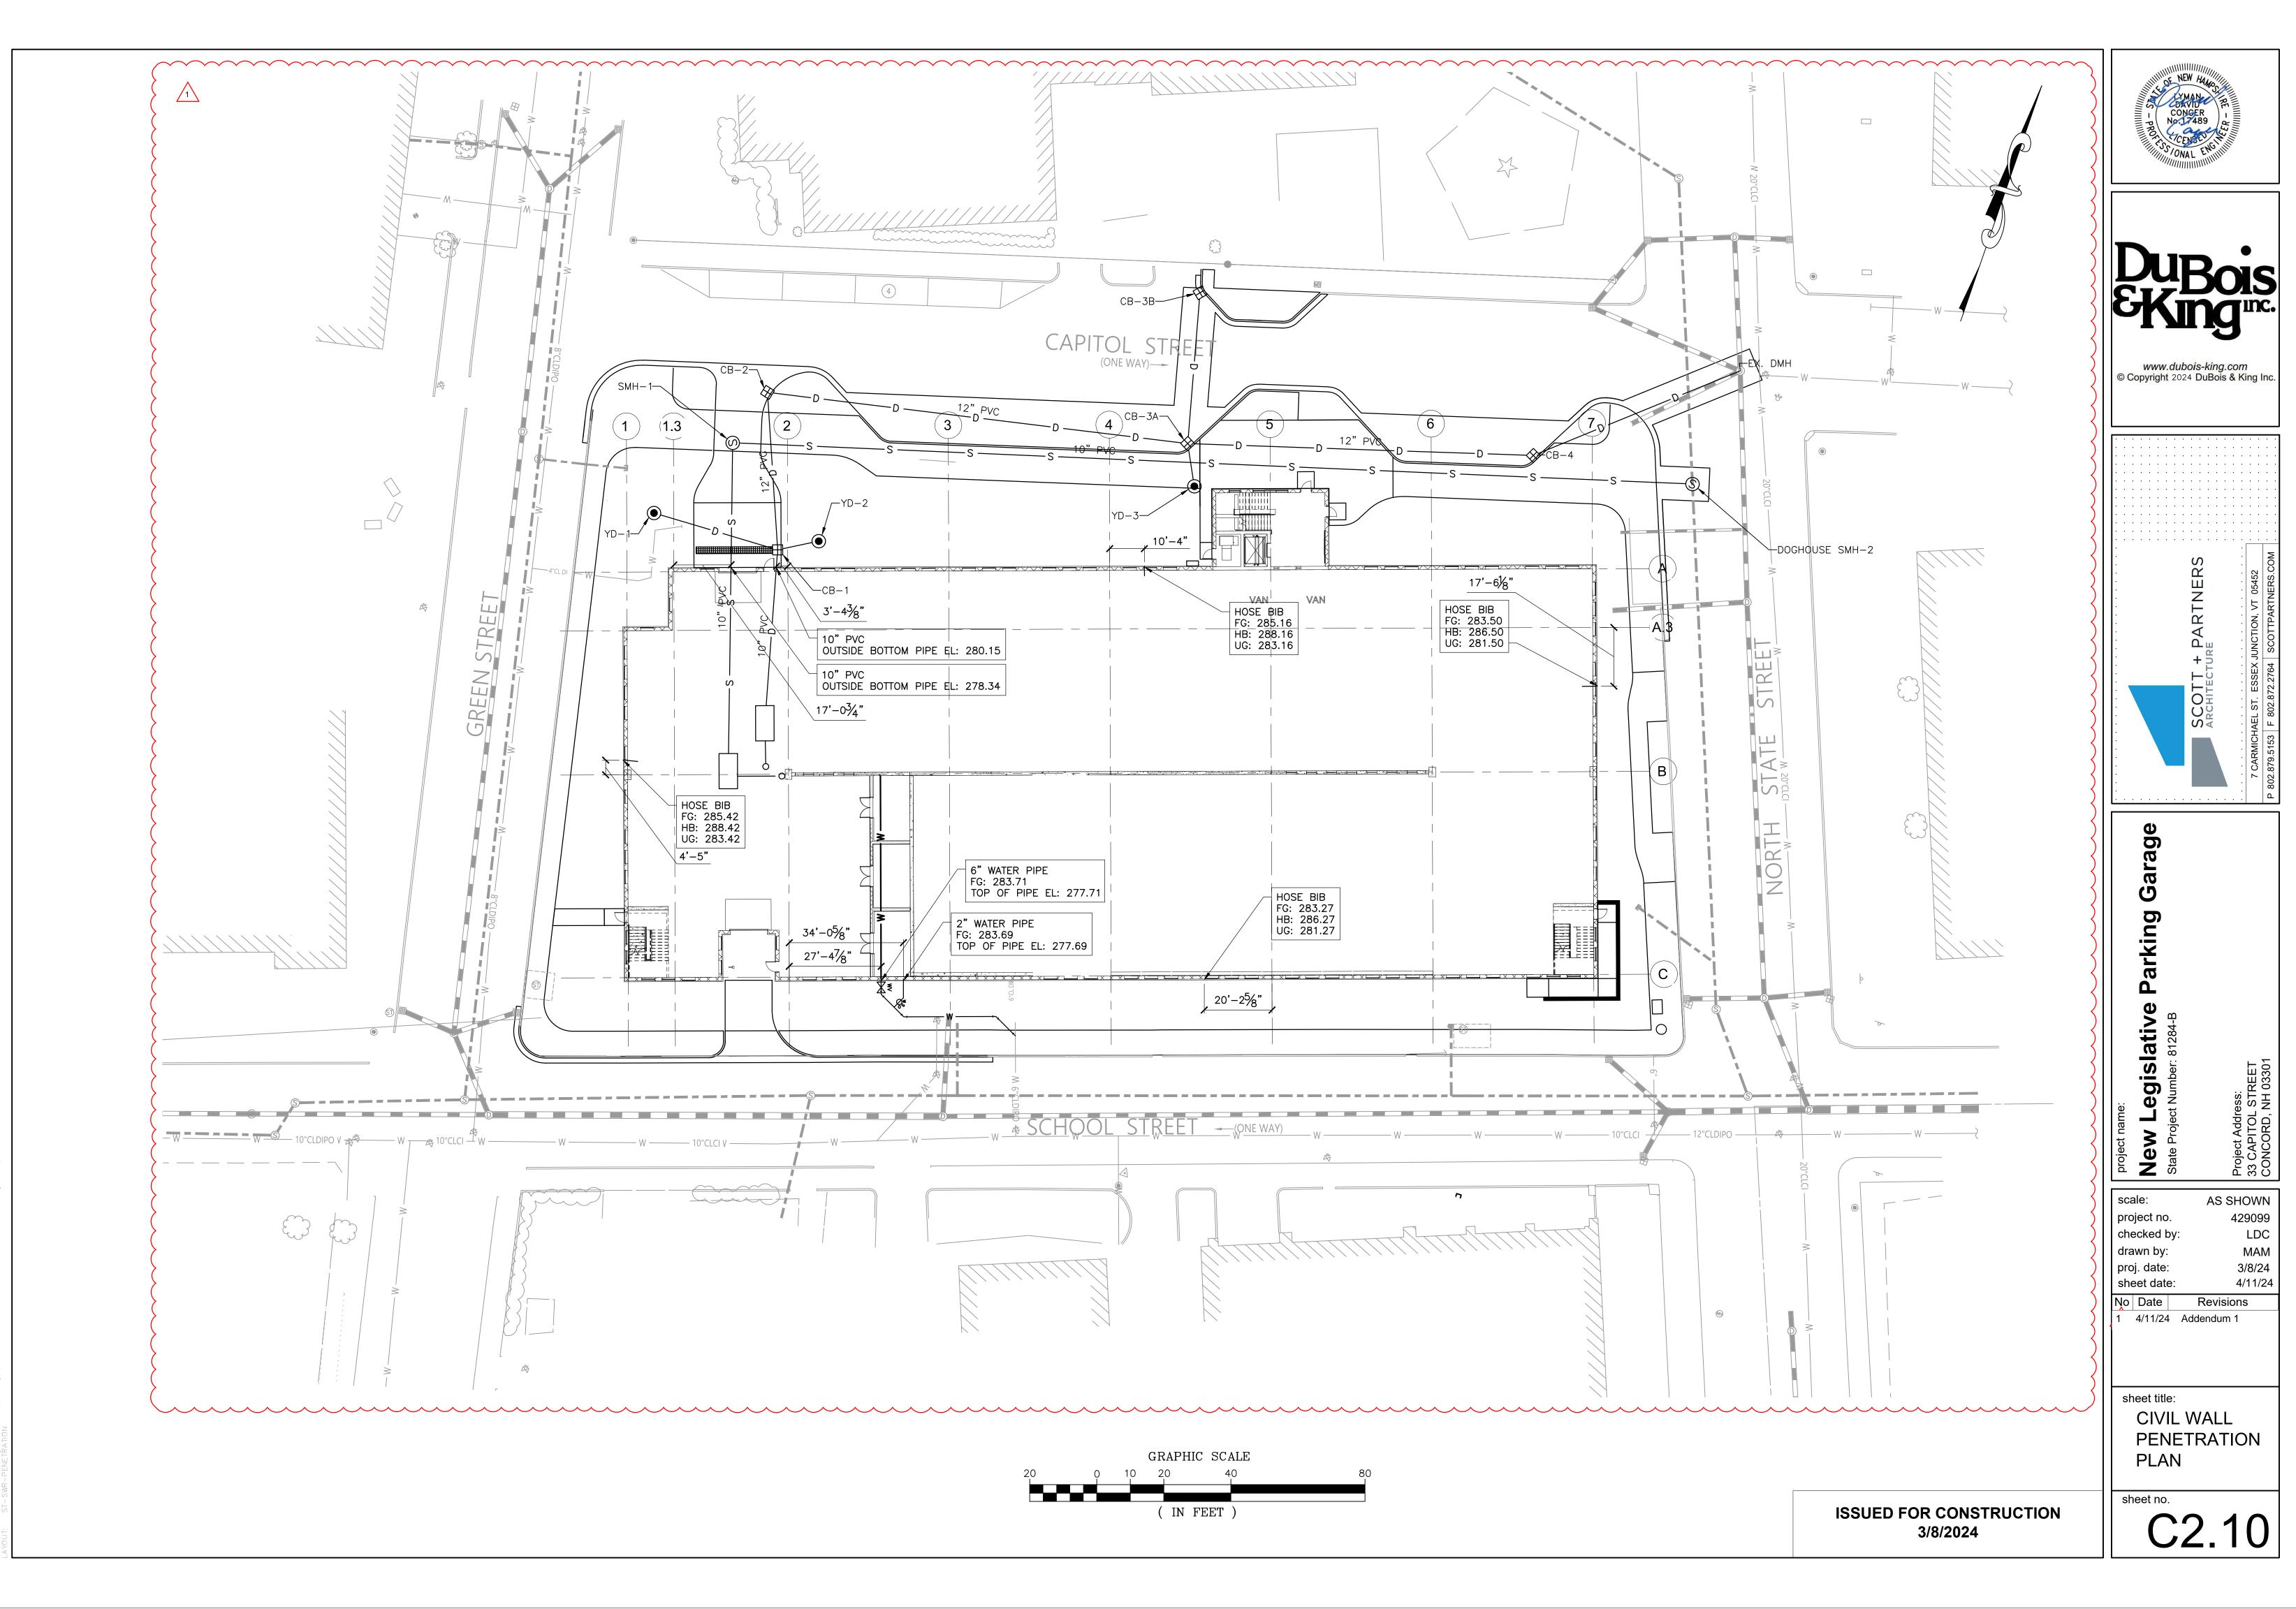

Drawings\429099_FOR_STORM—SEWER_PENETRATION.dwg 3/26/2024 12:01 PM

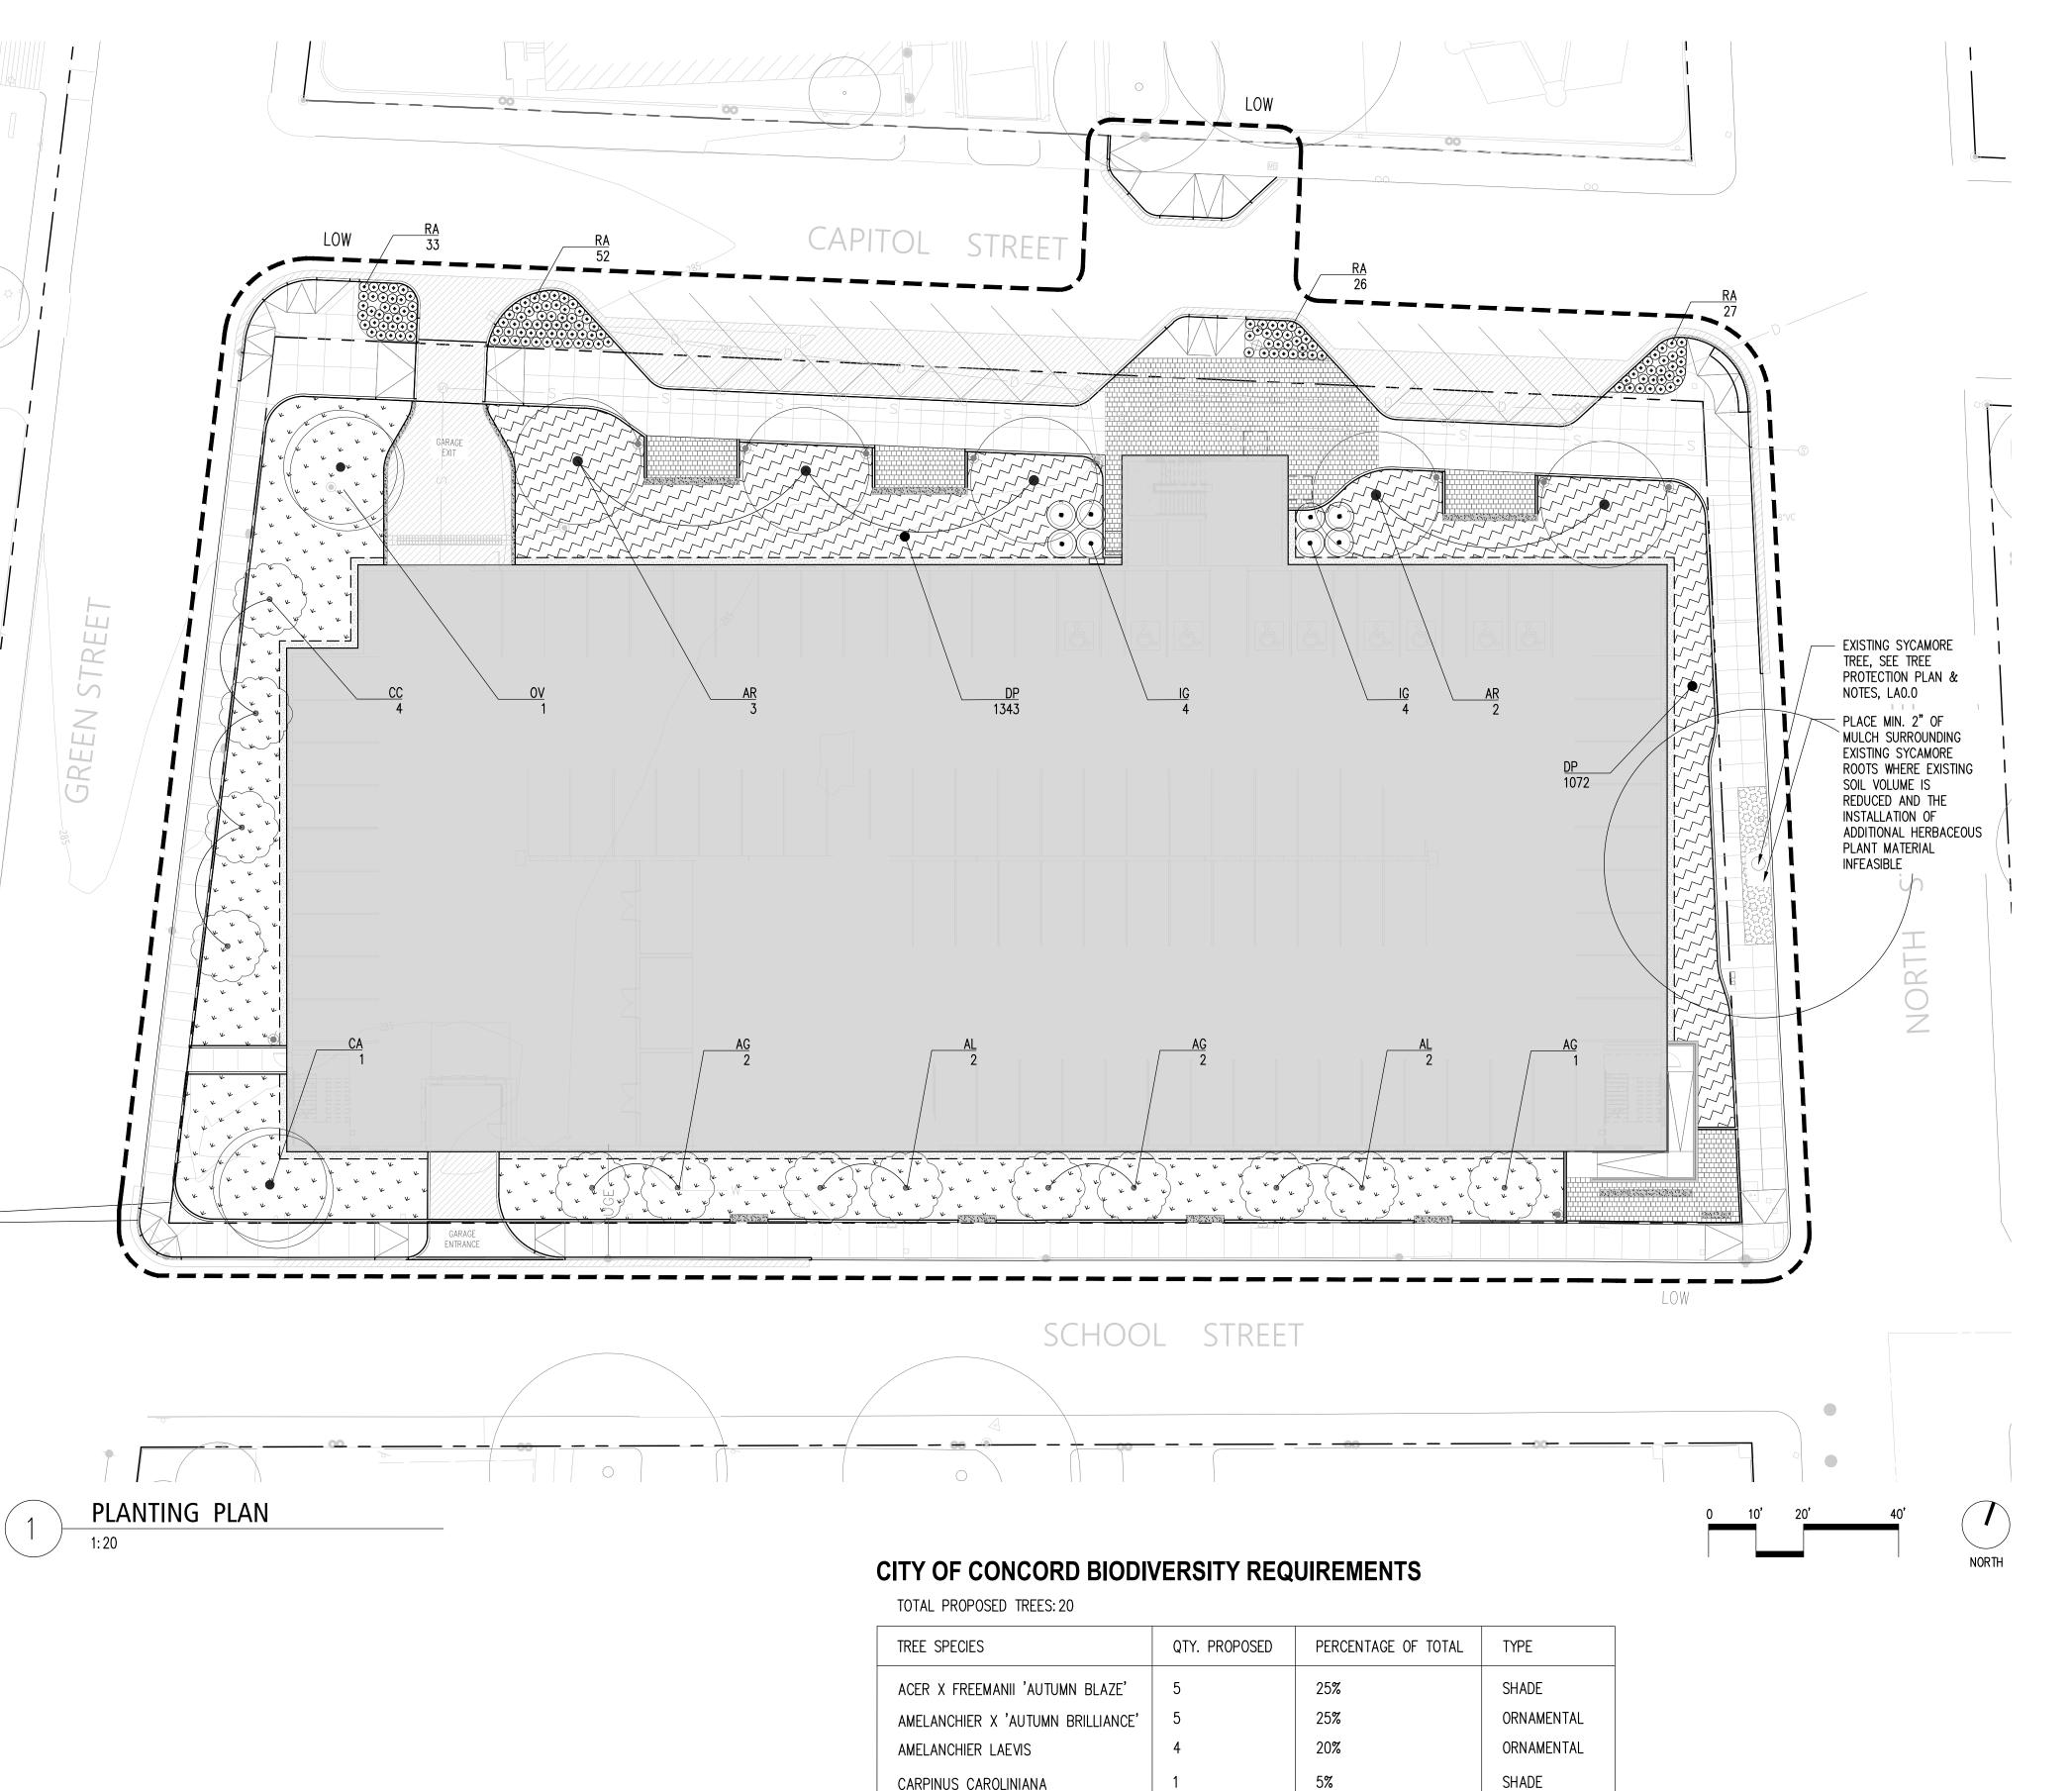

CERCIS CANADENSIS

OSTRYA VIRGINIANA

PERCENT ORNAMENTAL TREES:

35%

WHICH LISTS RECOMMENDED TREES FOR UNDER UTILITY WIRES.

PERCENT SHADE TREES:

20%

NOTE: PROPOSED TREE PLANTINGS DO NOT MEET CITY OF CONCORD'S BIODIVERSITY REQUIREMENTS REGARDING THE

OVERALL PERCENTAGE OF PROPOSED "ORNAMENTAL" TREES, DUE TO THE FACT THAT OVERHEAD WIRES RUN ALONG BOTH SCHOOL AND GREEN STREETS. THE PROPOSED PLANTINGS DO COMPLY WITH THE CITY OF CONCORD'S STREET TREE POLICY,

ORNAMENTAL

SHADE

LEGEND

— — — PROPERTY LINE

— — — LIMIT OF WORK

V v

PLANTING AREA

FYIS-

EXISTING TREE

PLANTING SCHEDULE

SYM.	KEY	QTY.	BOTANICAL NAME	COMMON NAME	SIZE	ROOT	SPACING
TREES	~~~~	$\sqrt{1}$					
	AR	5	ACER X FREEMANII 'AUTUMN BLAZE'	FREEMAN MAPLE	5" CAL.	B+B	PER PLAN
0	AG	5	AMELANCHIER x 'AUTUMN BRILLIANCE'	SERVICEBERRY	3.5" CAL.	B+B	PER PLAN
\odot	AL	4	AMELANCHIER LAEVIS	SERVICEBERRY	2.5" CAL.	B+B	PER PLAN
\bigcirc	CA	1	CARPINUS CAROLINIANA	IRONWOOD	3" CAL.	B+B	PER PLAN
\odot	CC	4	CERCIS CANADENSIS	EASTERN REDBUD	3" CAL.	B+B	PER PLAN
\bigcirc	OV	1	OSTRYA VIRGINIANA	HOP HORNBEAM	5" CAL.	B+B	PER PLAN
SHRUBS/	HERBAC	CEOUS PI	ERENNIALS				
O	IG	8	ILEX GLABRA 'DENSA'	DENSA INKBERRY	10 GAL.	CONT.	48" O.C.
•	RA	138	RHUS AROMATICA 'GROW-LOW'	FRAGRANT SUMAC	2 GAL.	CONT.	24" O.C.
SEMI-SHA	DE PLA	NTING PA	LETTE			•	
	DP	4717	DENNSTAEDTIA PUNCTILOBULA	HAY SCENTED FERN	8" POT	CONT.	16" O.C.
FULL SUN	I PLANTI	NG PALE	TTE				
V V V		6,300 SQFT	SEE SHEET LA3.1 FOR QTY & LAYOUT	ORNAMENTAL GRASS MIX	1 GAL.	CONT.	
SYCAMOR	RE TREE	WELL PL	ANTING PALETTE				
		110+/- SQFT	TBD; V.I.F. EXTENTS OF EXISTING TREE ROOTS TO DETERMINE AVAILABLE PLANTING SOIL AND FINAL PLANT SPECIFICATION	-	-	_	_

PLANTING NOTES

- 1. IF SUB-GRADE SOIL CONDITIONS ARE FOUND TO BE DELETERIOUS TO PLANT GROWTH OR WILL INHIBIT DRAINAGE, THE LANDSCAPE ARCHITECT SHALL BE NOTIFIED IMMEDIATELY AND PRIOR TO INSTALLATION OF PLANT MATERIAL.
- 2. TOPSOIL SHALL BE FREE FROM SUBSOIL, STONES LARGER THAN 1", OR ANY UNDESIRABLE MATERIAL, CONTAIN 5%
- ORGANIC MATTER AND HAVE A PH SUITABLE TO THE LOCAL GROWING CONDITIONS.

 4. THE PLANT LIST IS PROVIDED AS A CONVENIENCE. IN THE EVENT OF A DISCREPANCY BETWEEN THE PLANT COUNT
- SHOWN IN THE SCHEDULE AND THE DRAWING, THE DRAWING SHALL TAKE PRECEDENCE.

 5. ALL TREES ARE TO BE TAGGED IN THE NURSERY BY THE LANDSCAPE ARCHITECT. THE CONTRACTOR IS TO SUBMIT
- NURSERY PHOTOGRAPHS OF SHRUB AND HERBACEOUS PLANT MATERIAL TO THE LANDSCAPE ARCHITECT FOR APPROVAL PRIOR TO ACCEPTANCE.

 6. ALL PLANT MATERIAL DELIVERED TO THE SITE, INCLUDING TREES, SHRUBS, AND HERBACEOUS PERENNIALS SHALL BE
- LOCATED IN A TEMPORARY "NURSERY" IN A SHADED AREA PROTECTED FROM WIND. PLANTS SHALL BE WATERED AS NECESSARY UNTIL THEY CAN BE PLANTED. TRANSPLANTED PLANTS SHALL BE "HEELED IN" OR HEAVILY MULCHED WHILE LOCATED IN THE "NURSERY".
- 7. TREE LOCATIONS SHALL BE STAKED IN THE FIELD FOR REVIEW AND APPROVAL BY THE LANDSCAPE ARCHITECT PRIOR TO THE INSTALLATION OF ALL TREES. FINAL LOCATION OF ALL TREES IS TO BE DETERMINED IN THE FIELD BY THE LANDSCAPE ARCHITECT.
- 8. POTTED SHRUBS AND HERBACEOUS PERENNIALS SHALL BE LAID OUT IN THE FIELD FOR REVIEW AND APPROVAL BY
- THE LANDSCAPE ARCHITECT PRIOR TO INSTALLATION.

 9. PLANTS SHALL BEAR THE SAME RELATIONSHIP TO FINISHED GRADE AS EXISTED IN THE NURSERY.
- 10. CUT AND REMOVE BURLAP FROM TOP ⅓ OF ROOTBALL. CUT AND REMOVE AT LEAST ⅓ ½ OF WIRE BASKET. NYLON ROPE AND/OR NYLON BALLING MATERIAL IS NOT ACCEPTABLE.
- 11. STAKE TREES AS INDICATED IN PLANTING DETAILS.
- 12. TOPSOIL AND SEED ALL AREAS DISTURBED AS A RESULT OF ANY AND ALL DISTURBANCES, CONSTRUCTION, OR STORAGE OF EQUIPMENT WHETHER SUCH AREAS ARE SHOWN ON THE PLANS OR NOT.
- 13. ALL PERENNIAL AND SHRUB PLANTING BEDS ARE TO RECEIVE 2" MIN. LAYER OF DOUBLE SHREDDED HARDWOOD BARK MULCH. TREES PLANTED IN SEEDED PLANTING AREAS (OUTSIDE OF PLANTING BEDS) ARE TO RECEIVE 2" MIN. LAYER OF DOUBLE SHREDDED HARDWOOD BARK MULCH WITHIN WATERING BASIN FORMED BY 3" BERMS (PER TREE PLANTING DETAILS).
- 14. ADJUST OR REMOVE ALL STAKES AFTER 1 YEAR, MAXIMUM.
- 15. REFER TO PLANTING DETAILS, LAS.3.
- 16. PERFORM THE FOLLOWING TREE MAINTENANCE ACTIONS ON THE EXISTING SYCAMORE TREE ON NORTH STATE STREET, AS RECOMMENDED BY SAVEATREE'S CERTIFIED ARBORIST ON 11/29/2023. CONFIRM ALL MAINTENANCE AND TREE CARE RECOMMENDATIONS WITH SAVATREE OR AN ALTERNATIVE, APPROVED CERTIFIED ARBORIST, PRIOR TO THE IMPLEMENTATION OF TREECARE RECOMMENDATIONS.
- 16.1. PROVIDE EARLY SEASON FERTILIZER TO DELIVER ORGANIC MATERIALS AND KEY MICRO AND MACRO NUTRIENTS TO THE TREE.
- 16.2. MONITOR FOR ANTHRACNOSE DISEASE AND TREAT AS NEEDED OR PREVENTATIVELY.
- 16.3. SAVATREE CONTACT INFORMATION: RYAN BARDZIK, ISA CERTIFIED ARBORIST, (603) 332-1246

mblainc
michael boucher landscape architecture
457 US Route 1 Suite 2
Freeport, ME 04032
t 207.865.1080
www.boucherlandscape.com
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RS : 20

SCOTT + PARTNE

ect name:

W Legislative Parking Garage

project number: 81284-B

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1	4/11/24	Addendum 1
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CAPITOL STREET INCORD, NH, 0330

sheet title:
PLANTING
PLAN

sheet r

sheet no.

ISSUED FOR CONSTRUCTION 03/08/2024



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No	Date	Revisions
1	4/11/24	Addendum 1

sheet title: SITE **ELEVATIONS**

sheet no.

LA4.0

STATE STREET SECTION ELEVATION

ISSUED FOR CONSTRUCTION 03/08/2024

LED LIGHT BOLLARD

SIGNAL BOX, EXISTING


STREET LIGHT, EXISTING

LED LIGHT POLE


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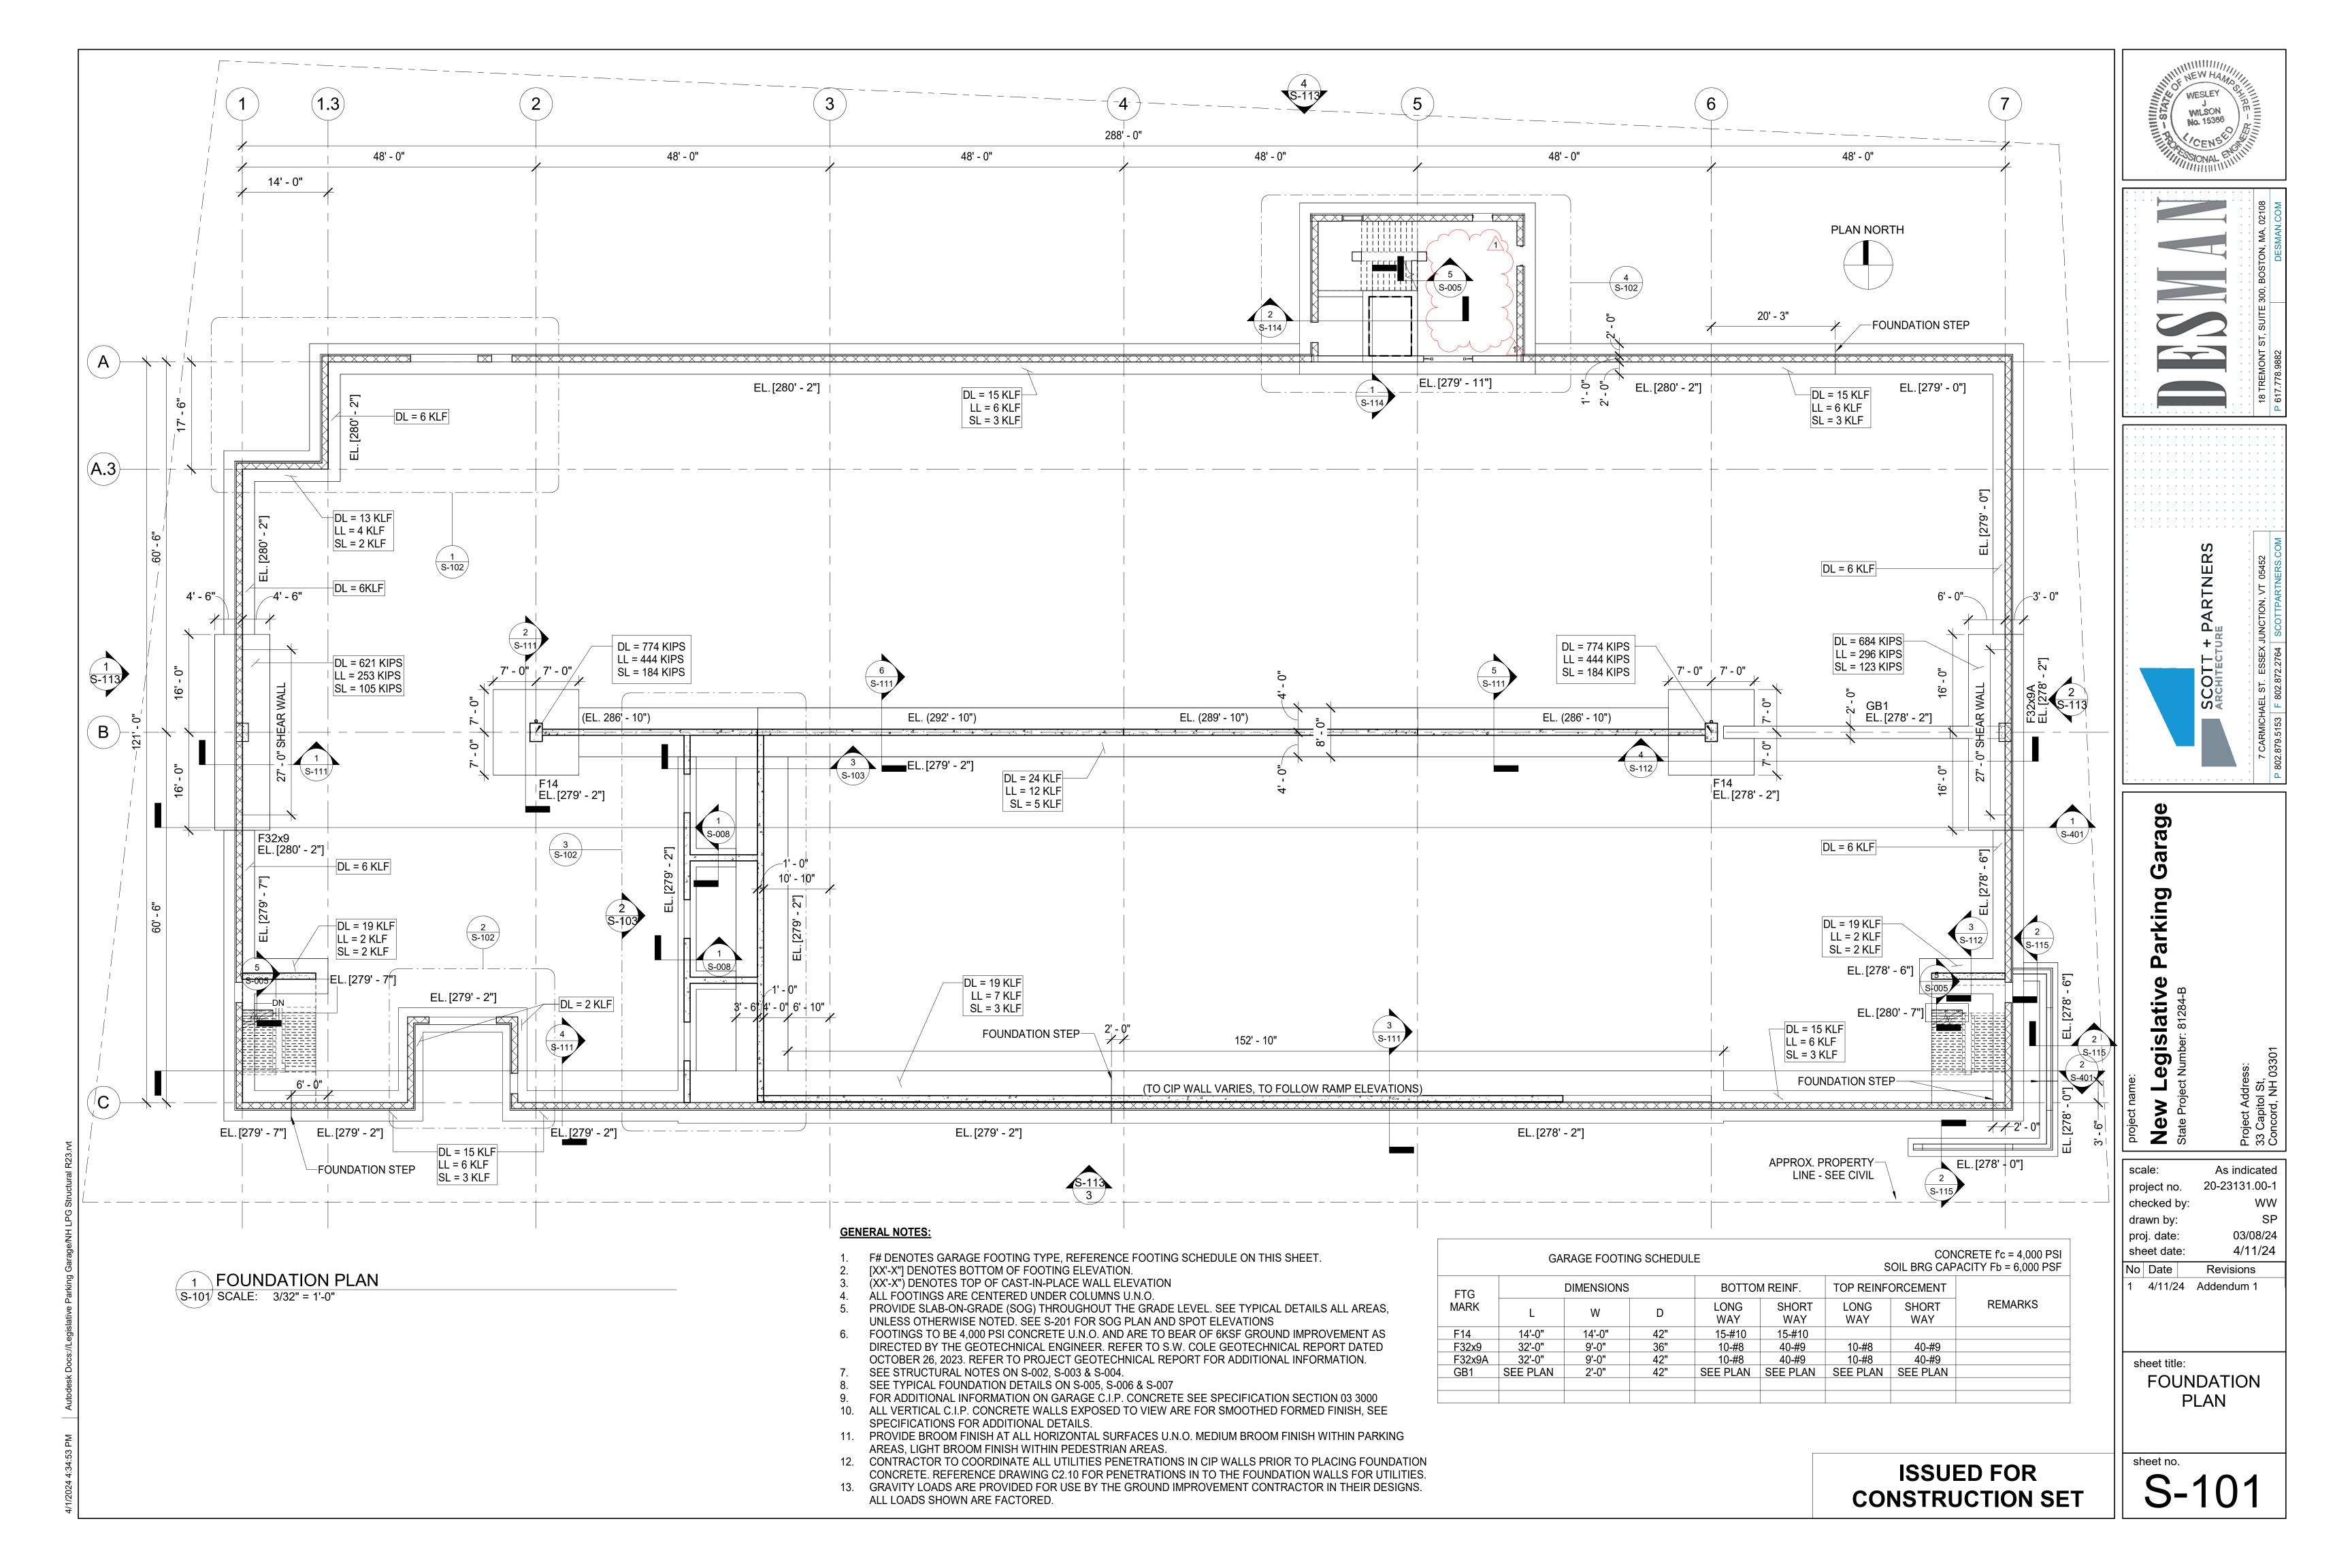
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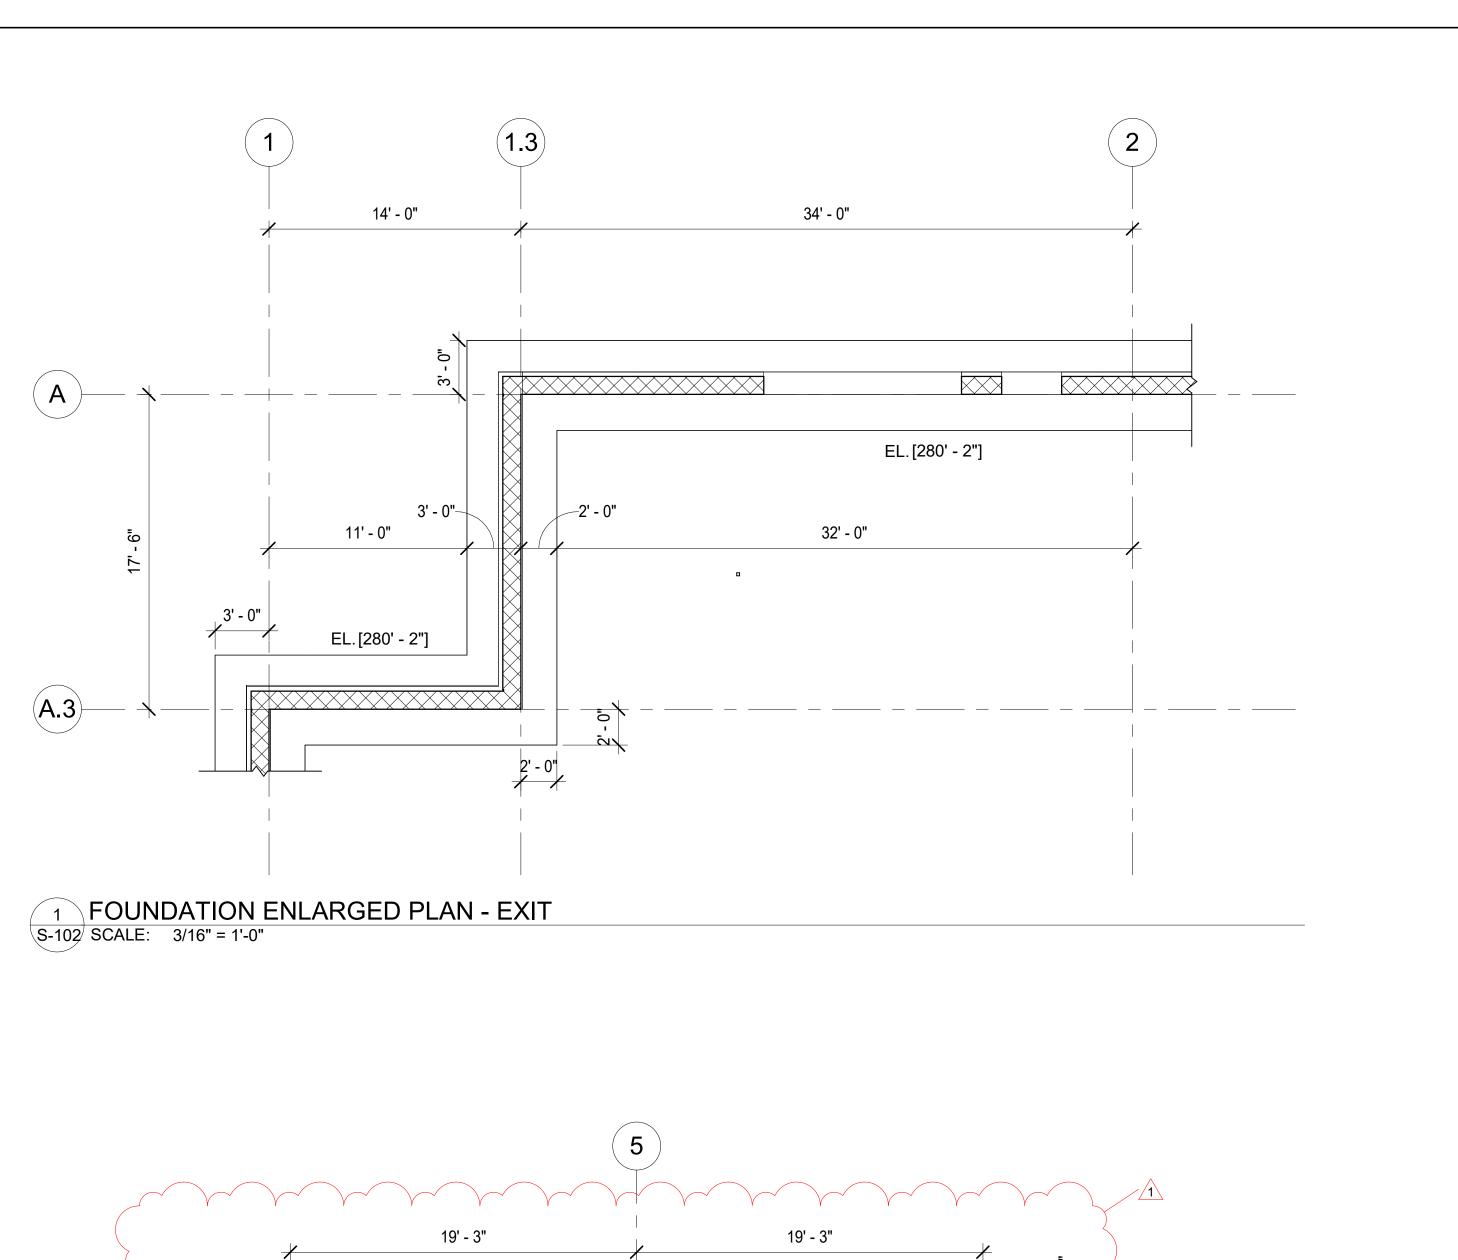
MICELLANEOUS ITEMS




03/08/2024

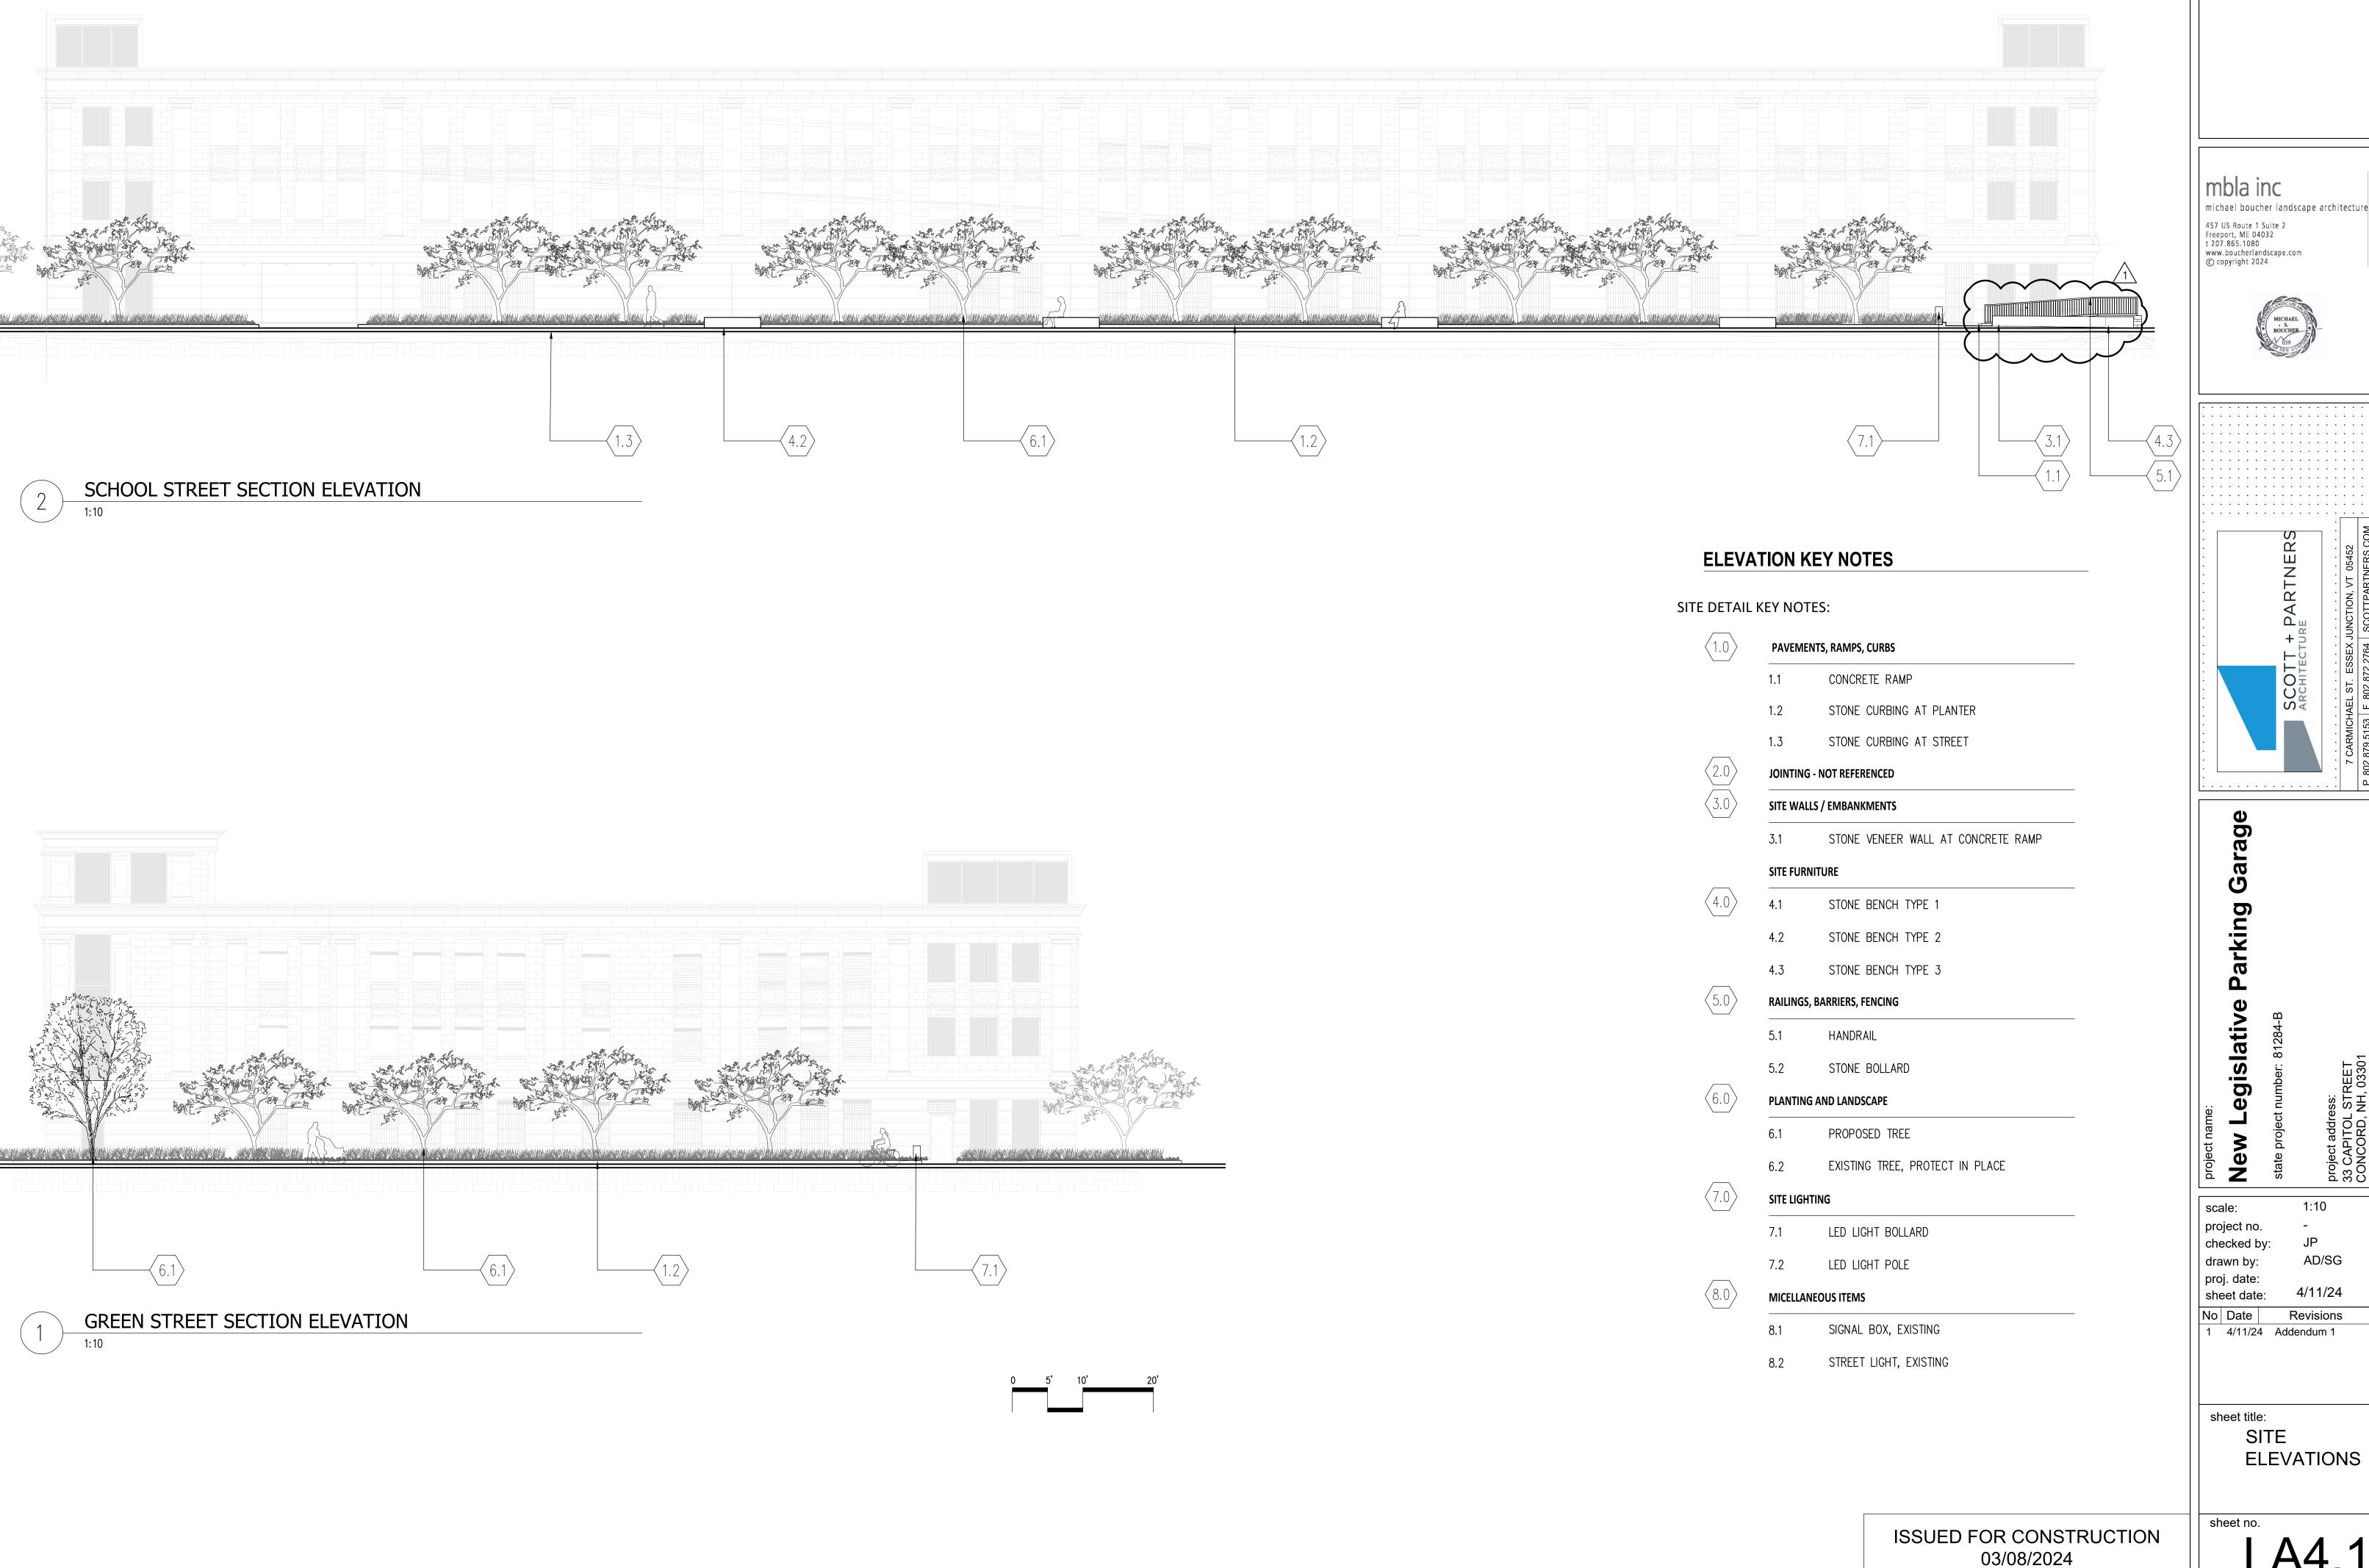



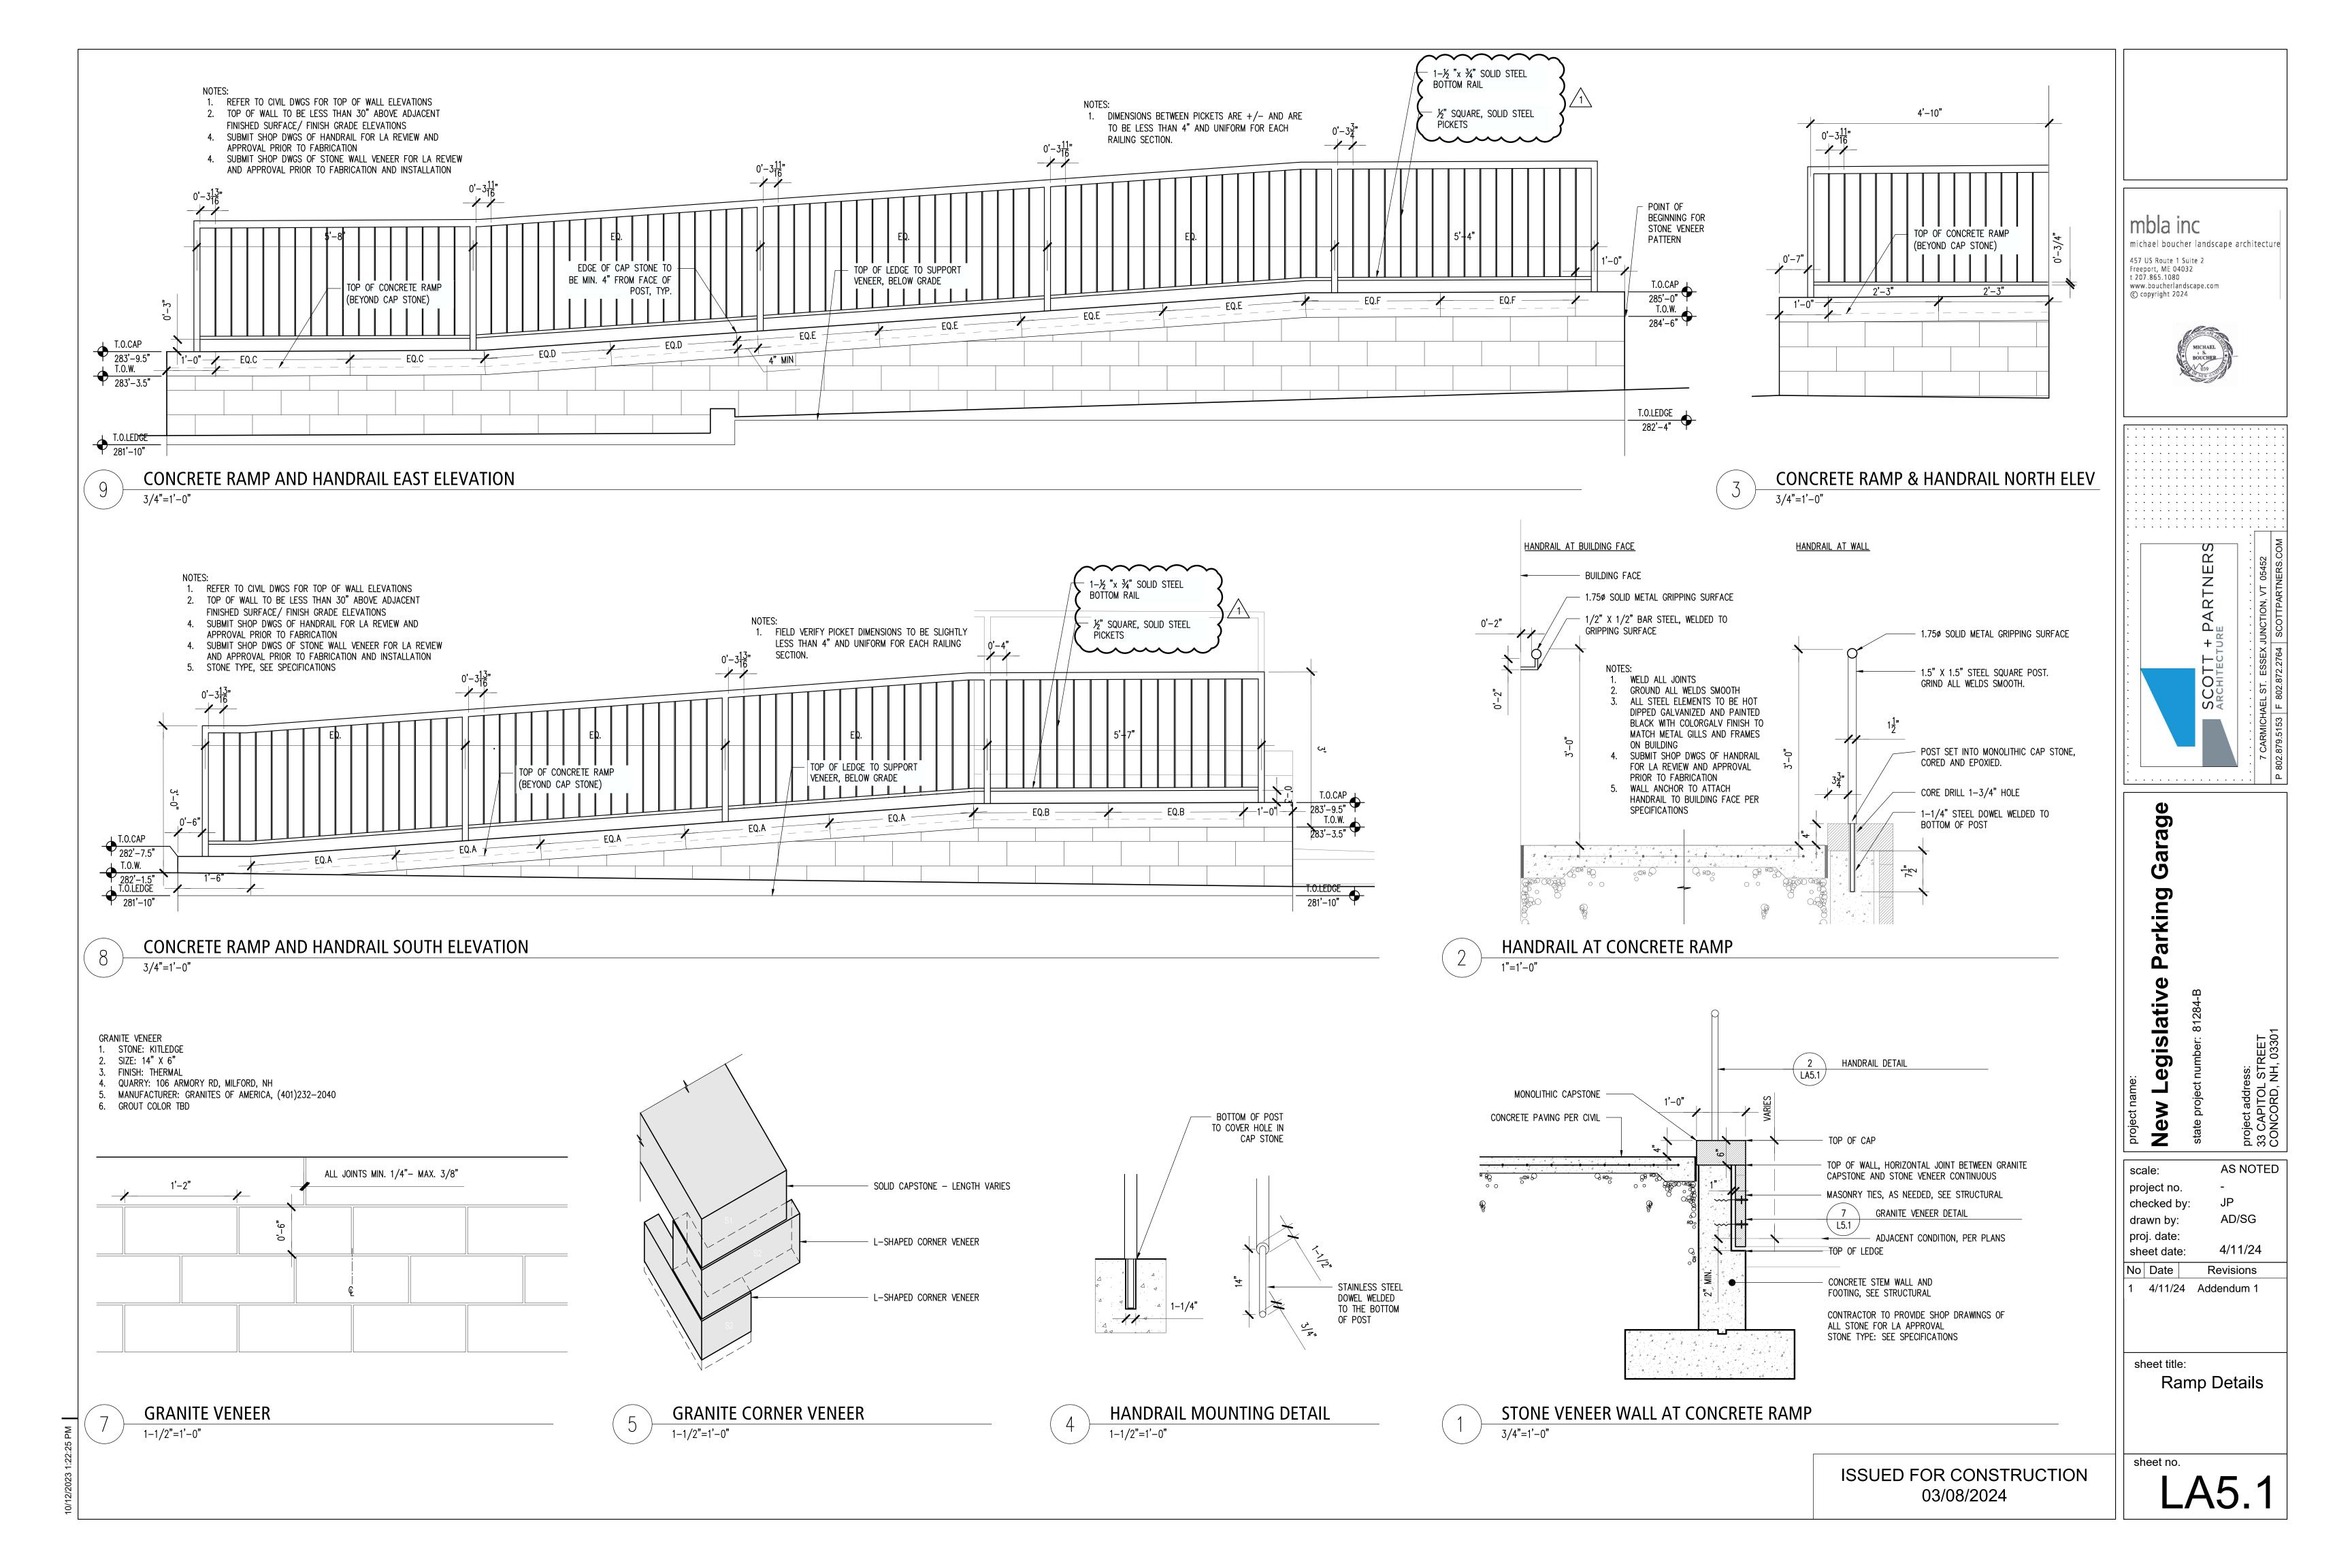

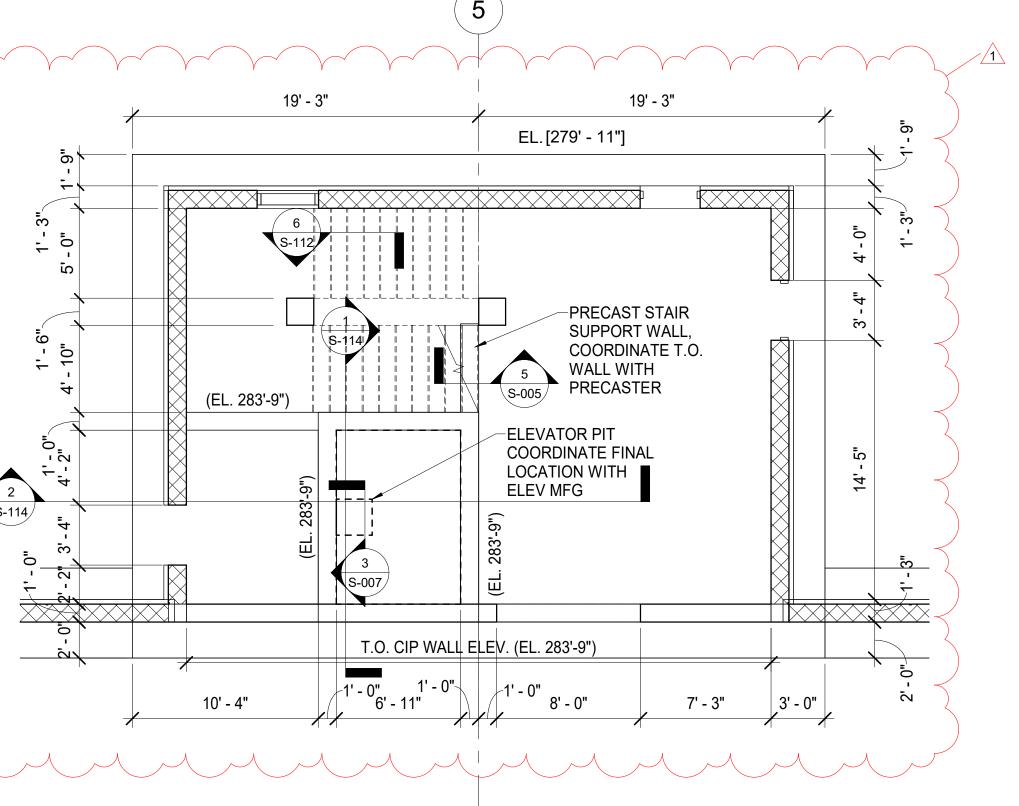

4 FOUNDATION ENLARGED PLAN - STAIRTOWER
S-102 SCALE: 3/16" = 1'-0"




C

21' - 0"


13' - 0"

EL.[279' - 2"]

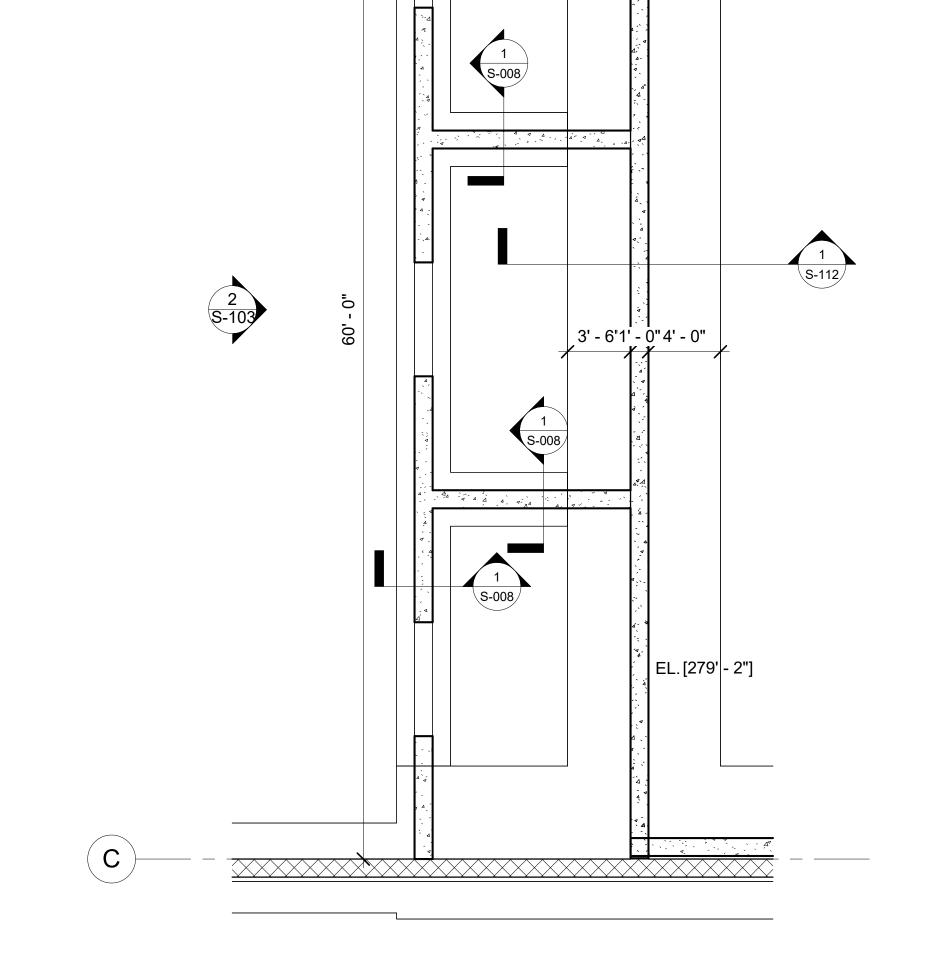

3 FOUNDATION ENLARGED PLAN - UNDER RAMP ROOMS
S-102 SCALE: 3/16" = 1'-0"

ISSUED FOR CONSTRUCTION SET

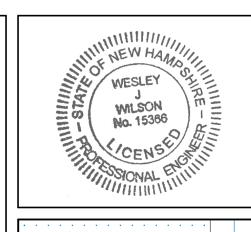

New Legislative State Project Number: 81284-B


3/16" = 1'-0" scale: 20-23131.00-1 project no. checked by: SP drawn by: 03/08/24 proj. date: 4/11/24 sheet date: Revisions

No Date 1 4/11/24 Addendum 1

sheet title: **ENLARGED FOUNDATION**

PLANS sheet no.

S-102

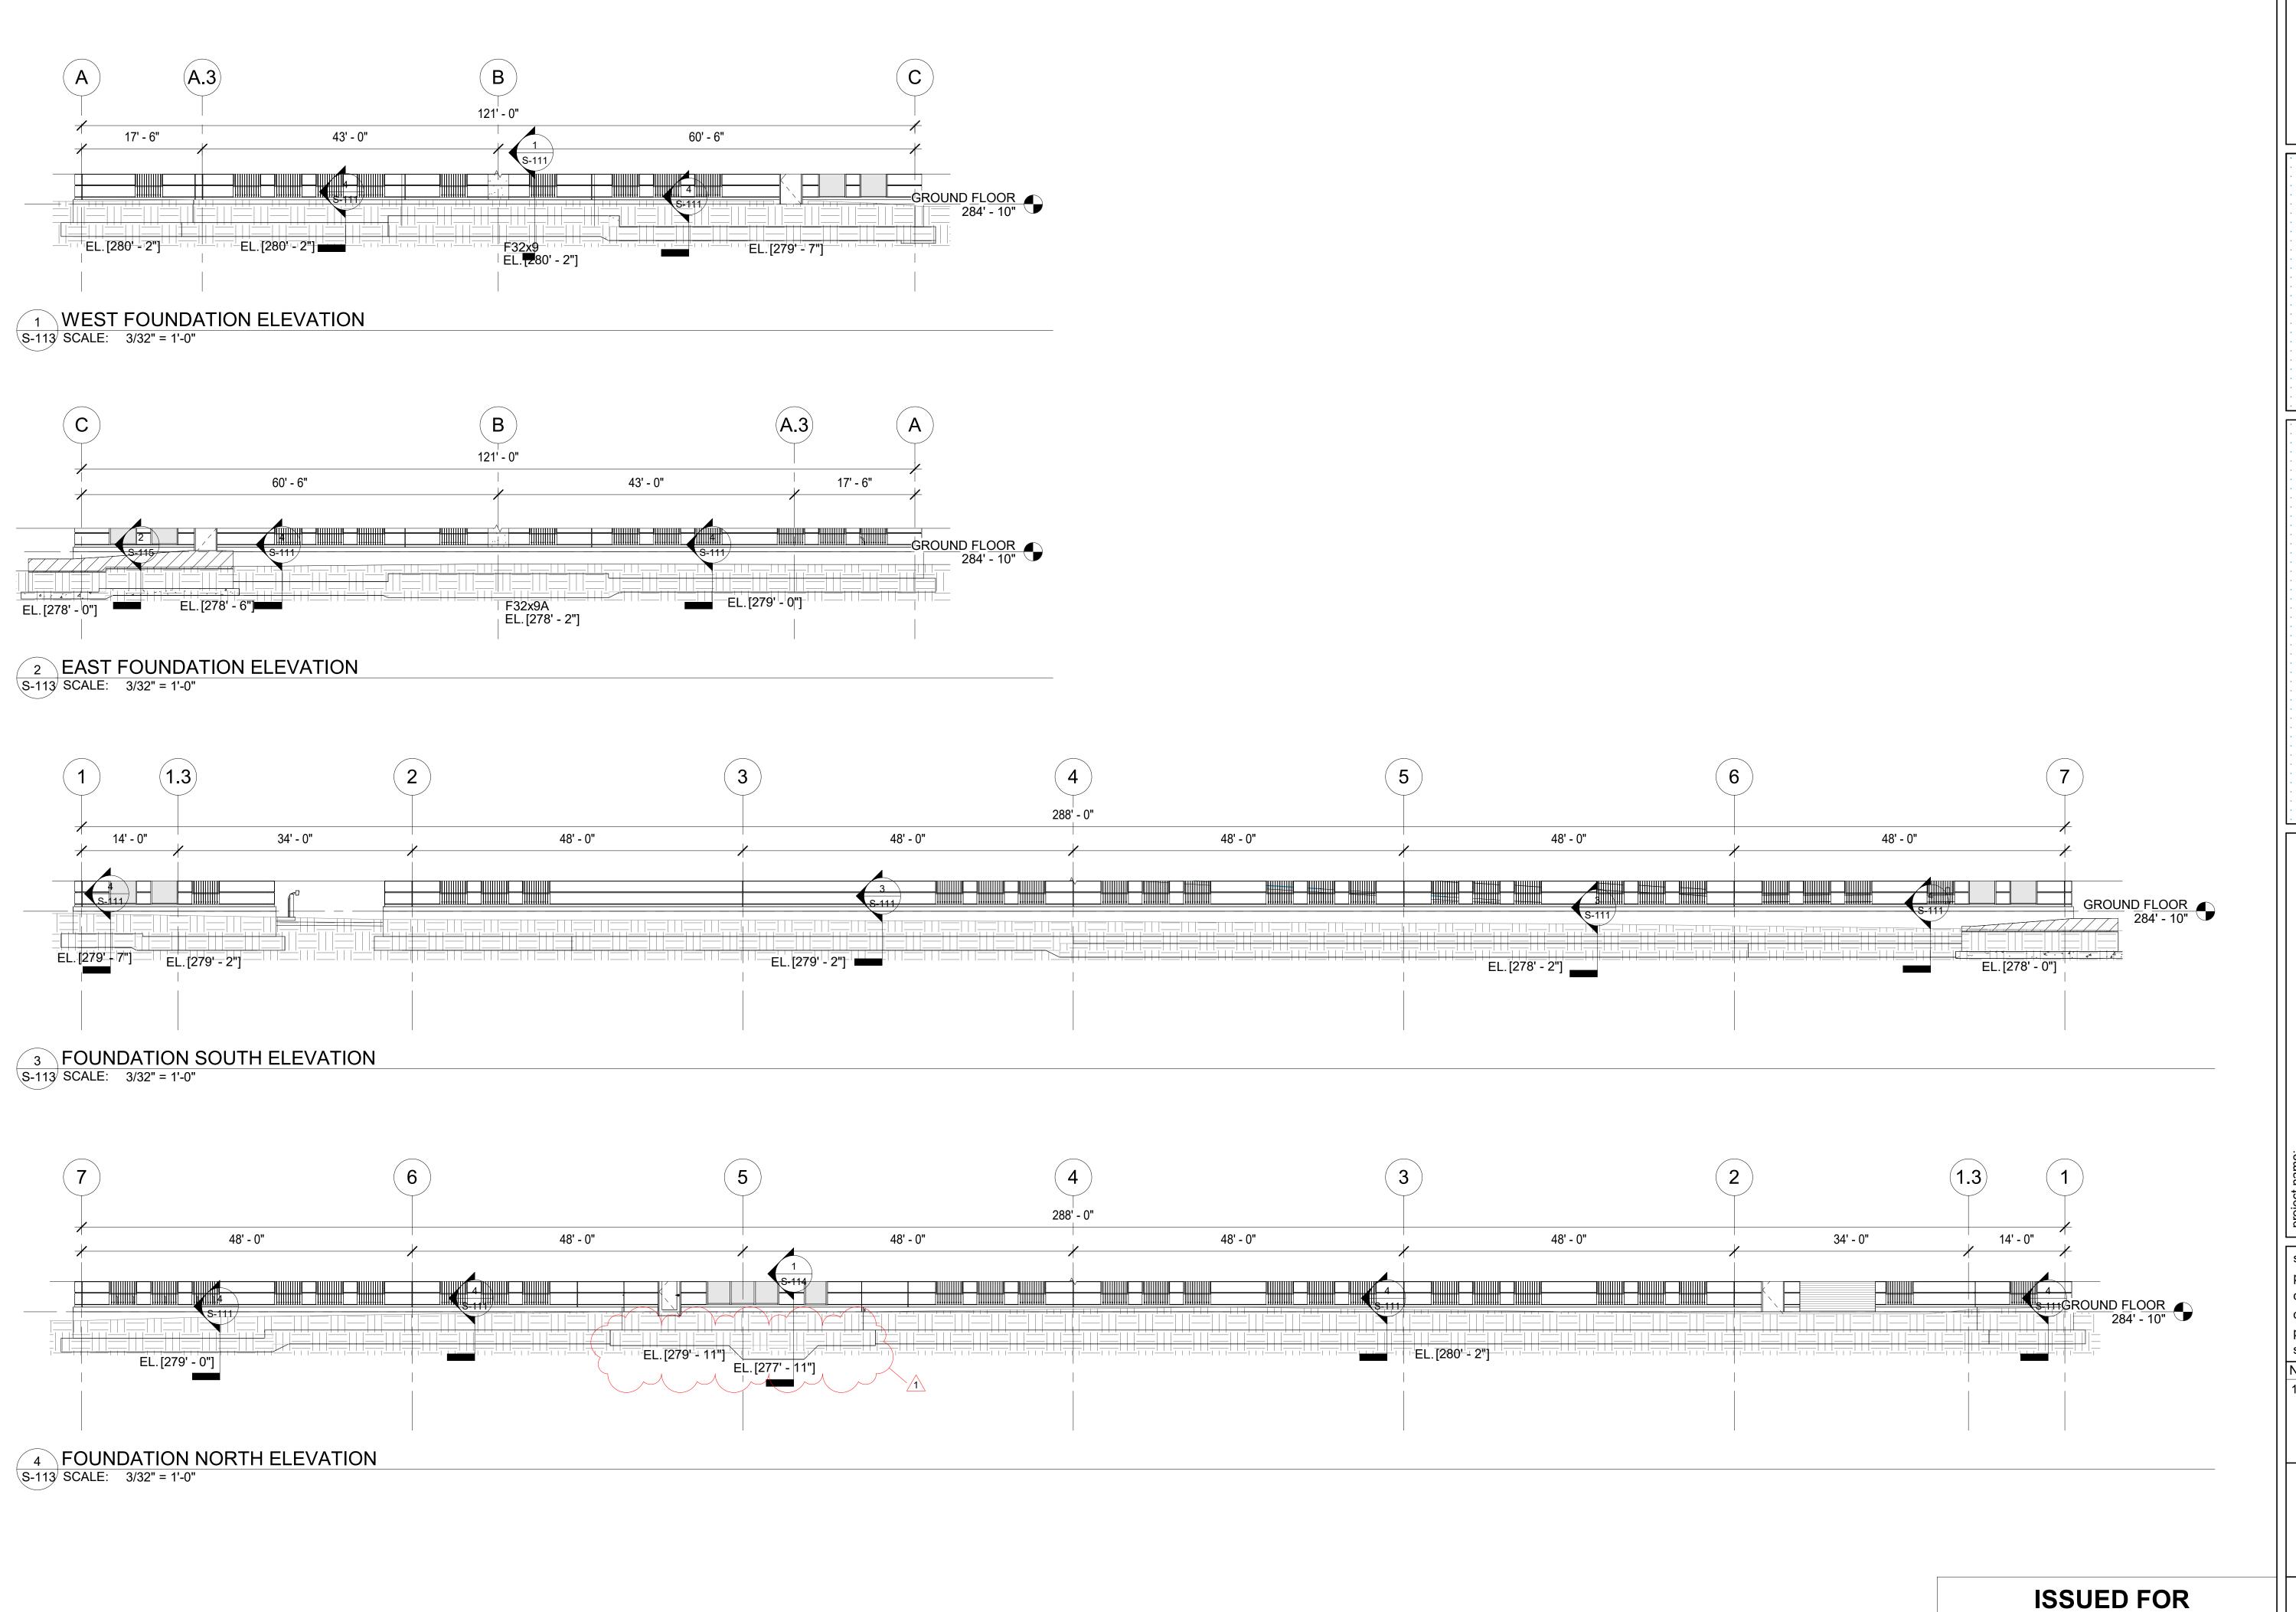

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WESLEY
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NO. 15386

WESLEY
WILSON
NO. 15386

18 TREMONT ST, SUITE 300, BOSTON, MA, 02108

SCOTT + PARTNERS
ARCHITECTURE
7 CARMICHAEL ST. ESSEX JUNCTION, VT 05452

Project hame:

New Legislative Parking Garage
State Project Number: 81284-B
Project Address:

 scale:
 3/32" = 1'-0"

 project no.
 20-23131.00-1

 checked by:
 WW

 drawn by:
 SP

 proj. date:
 03/08/24

 sheet date:
 4/11/24


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1 4/11/24 Addendum 1


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FOUNDATION
ELEVATIONS

sheet no.


CONSTRUCTION SET

S-113

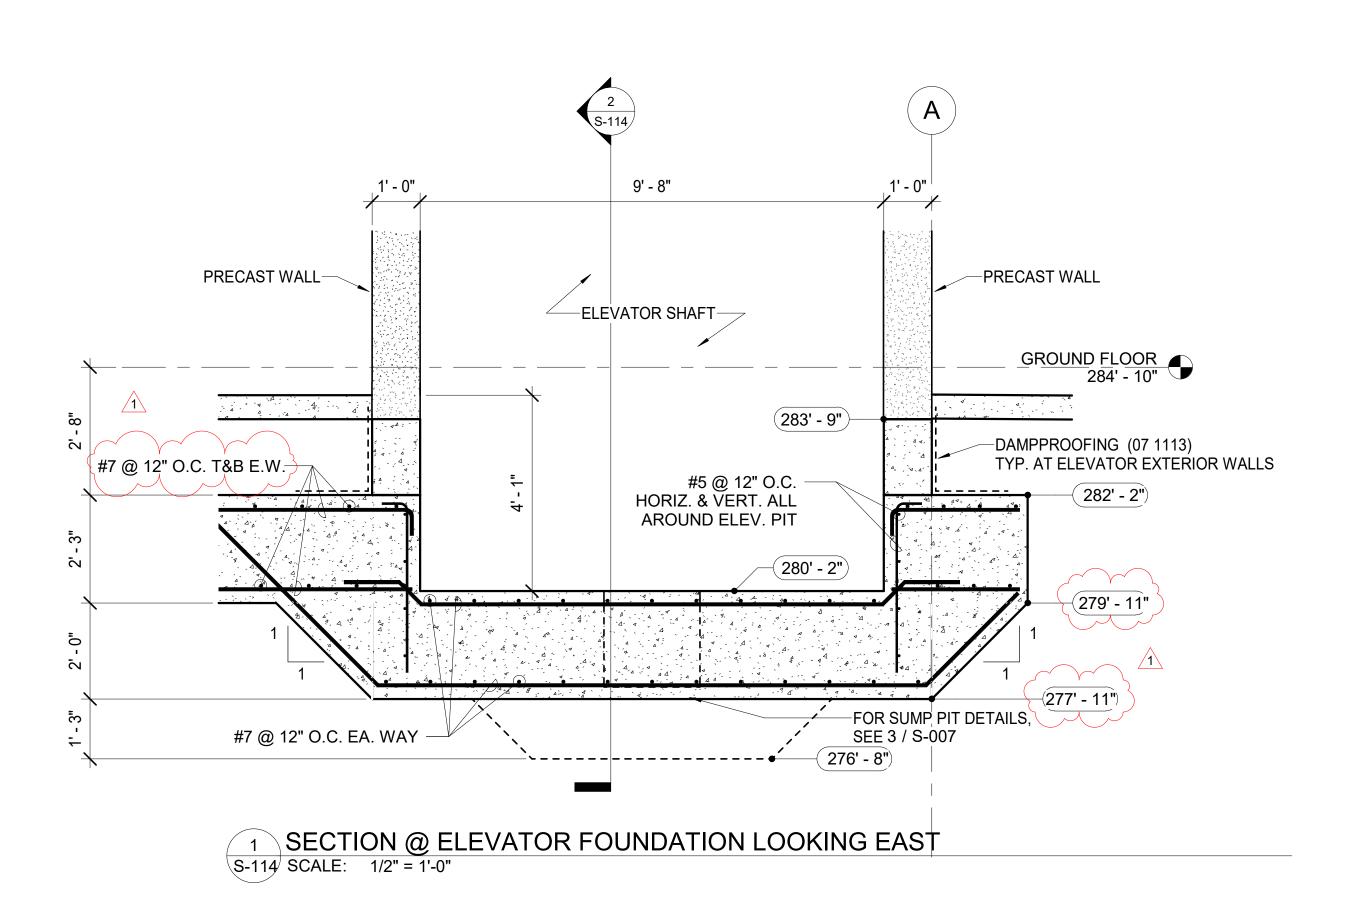

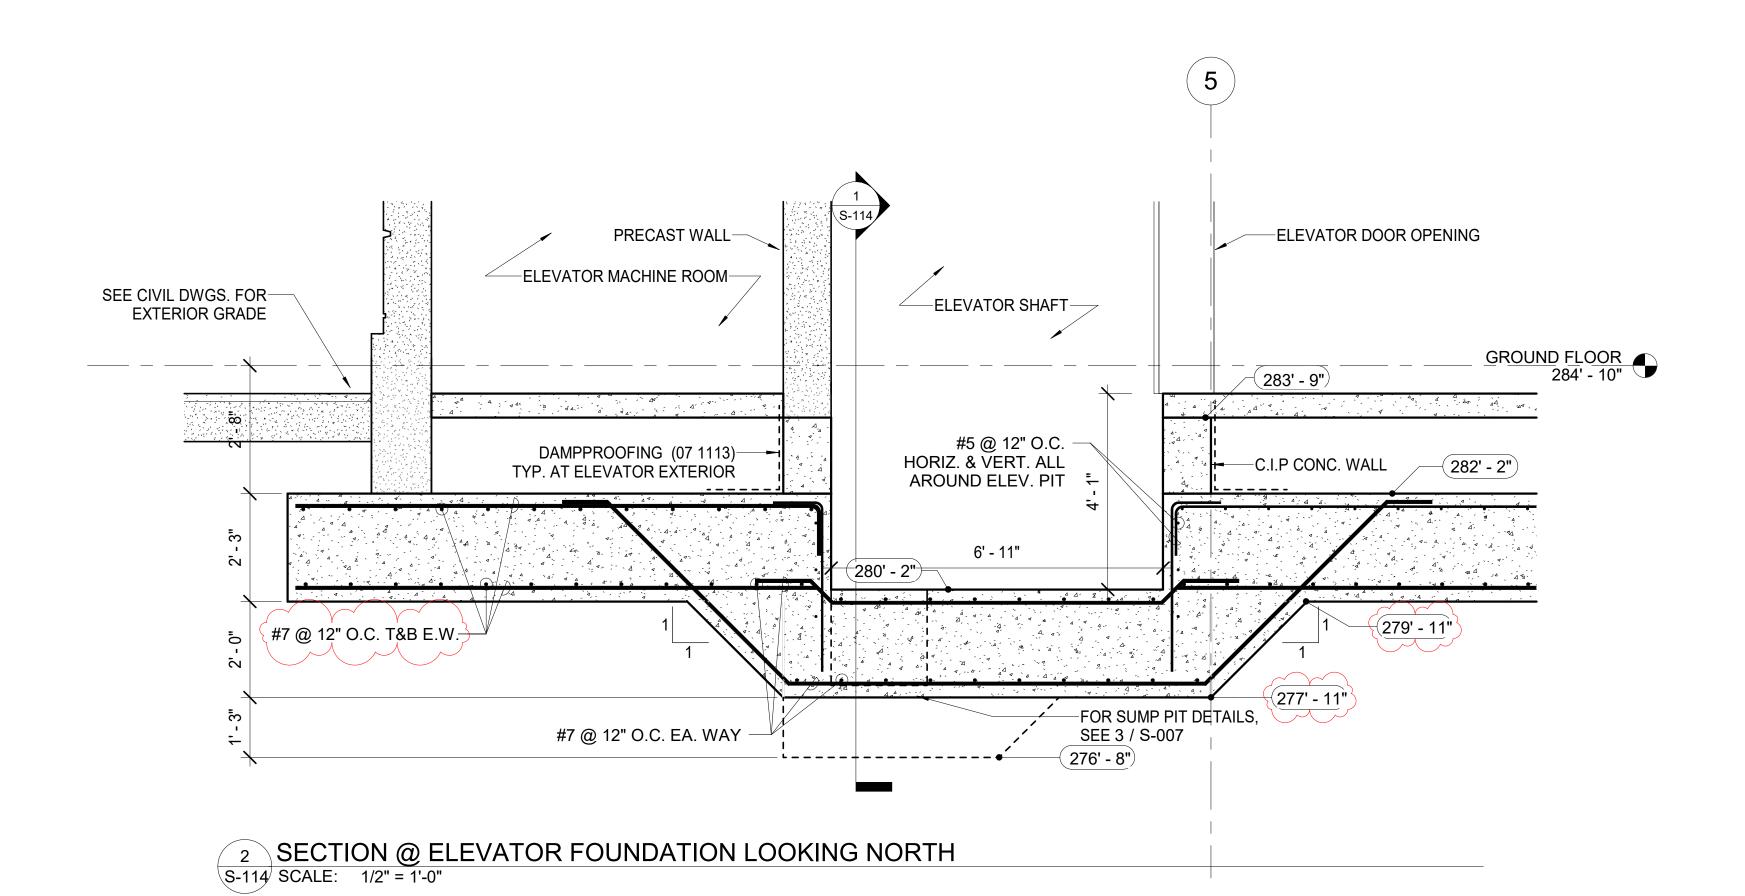



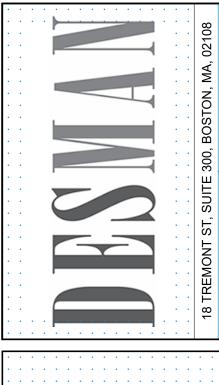

SCOTT + PARTNERS
ARCHITECTURE

New Legislative Parking Garage State Project Number: 81284-B Project Address: 33 Capitol St,

 scale:
 1/2" = 1'-0"

 project no.
 20-23131.00-1

 checked by:
 WW

 drawn by:
 SP

 proj. date:
 03/08/24

 sheet date:
 4/11/24

No Date Revisions

1 4/11/24 Addendum 1

sheet title:


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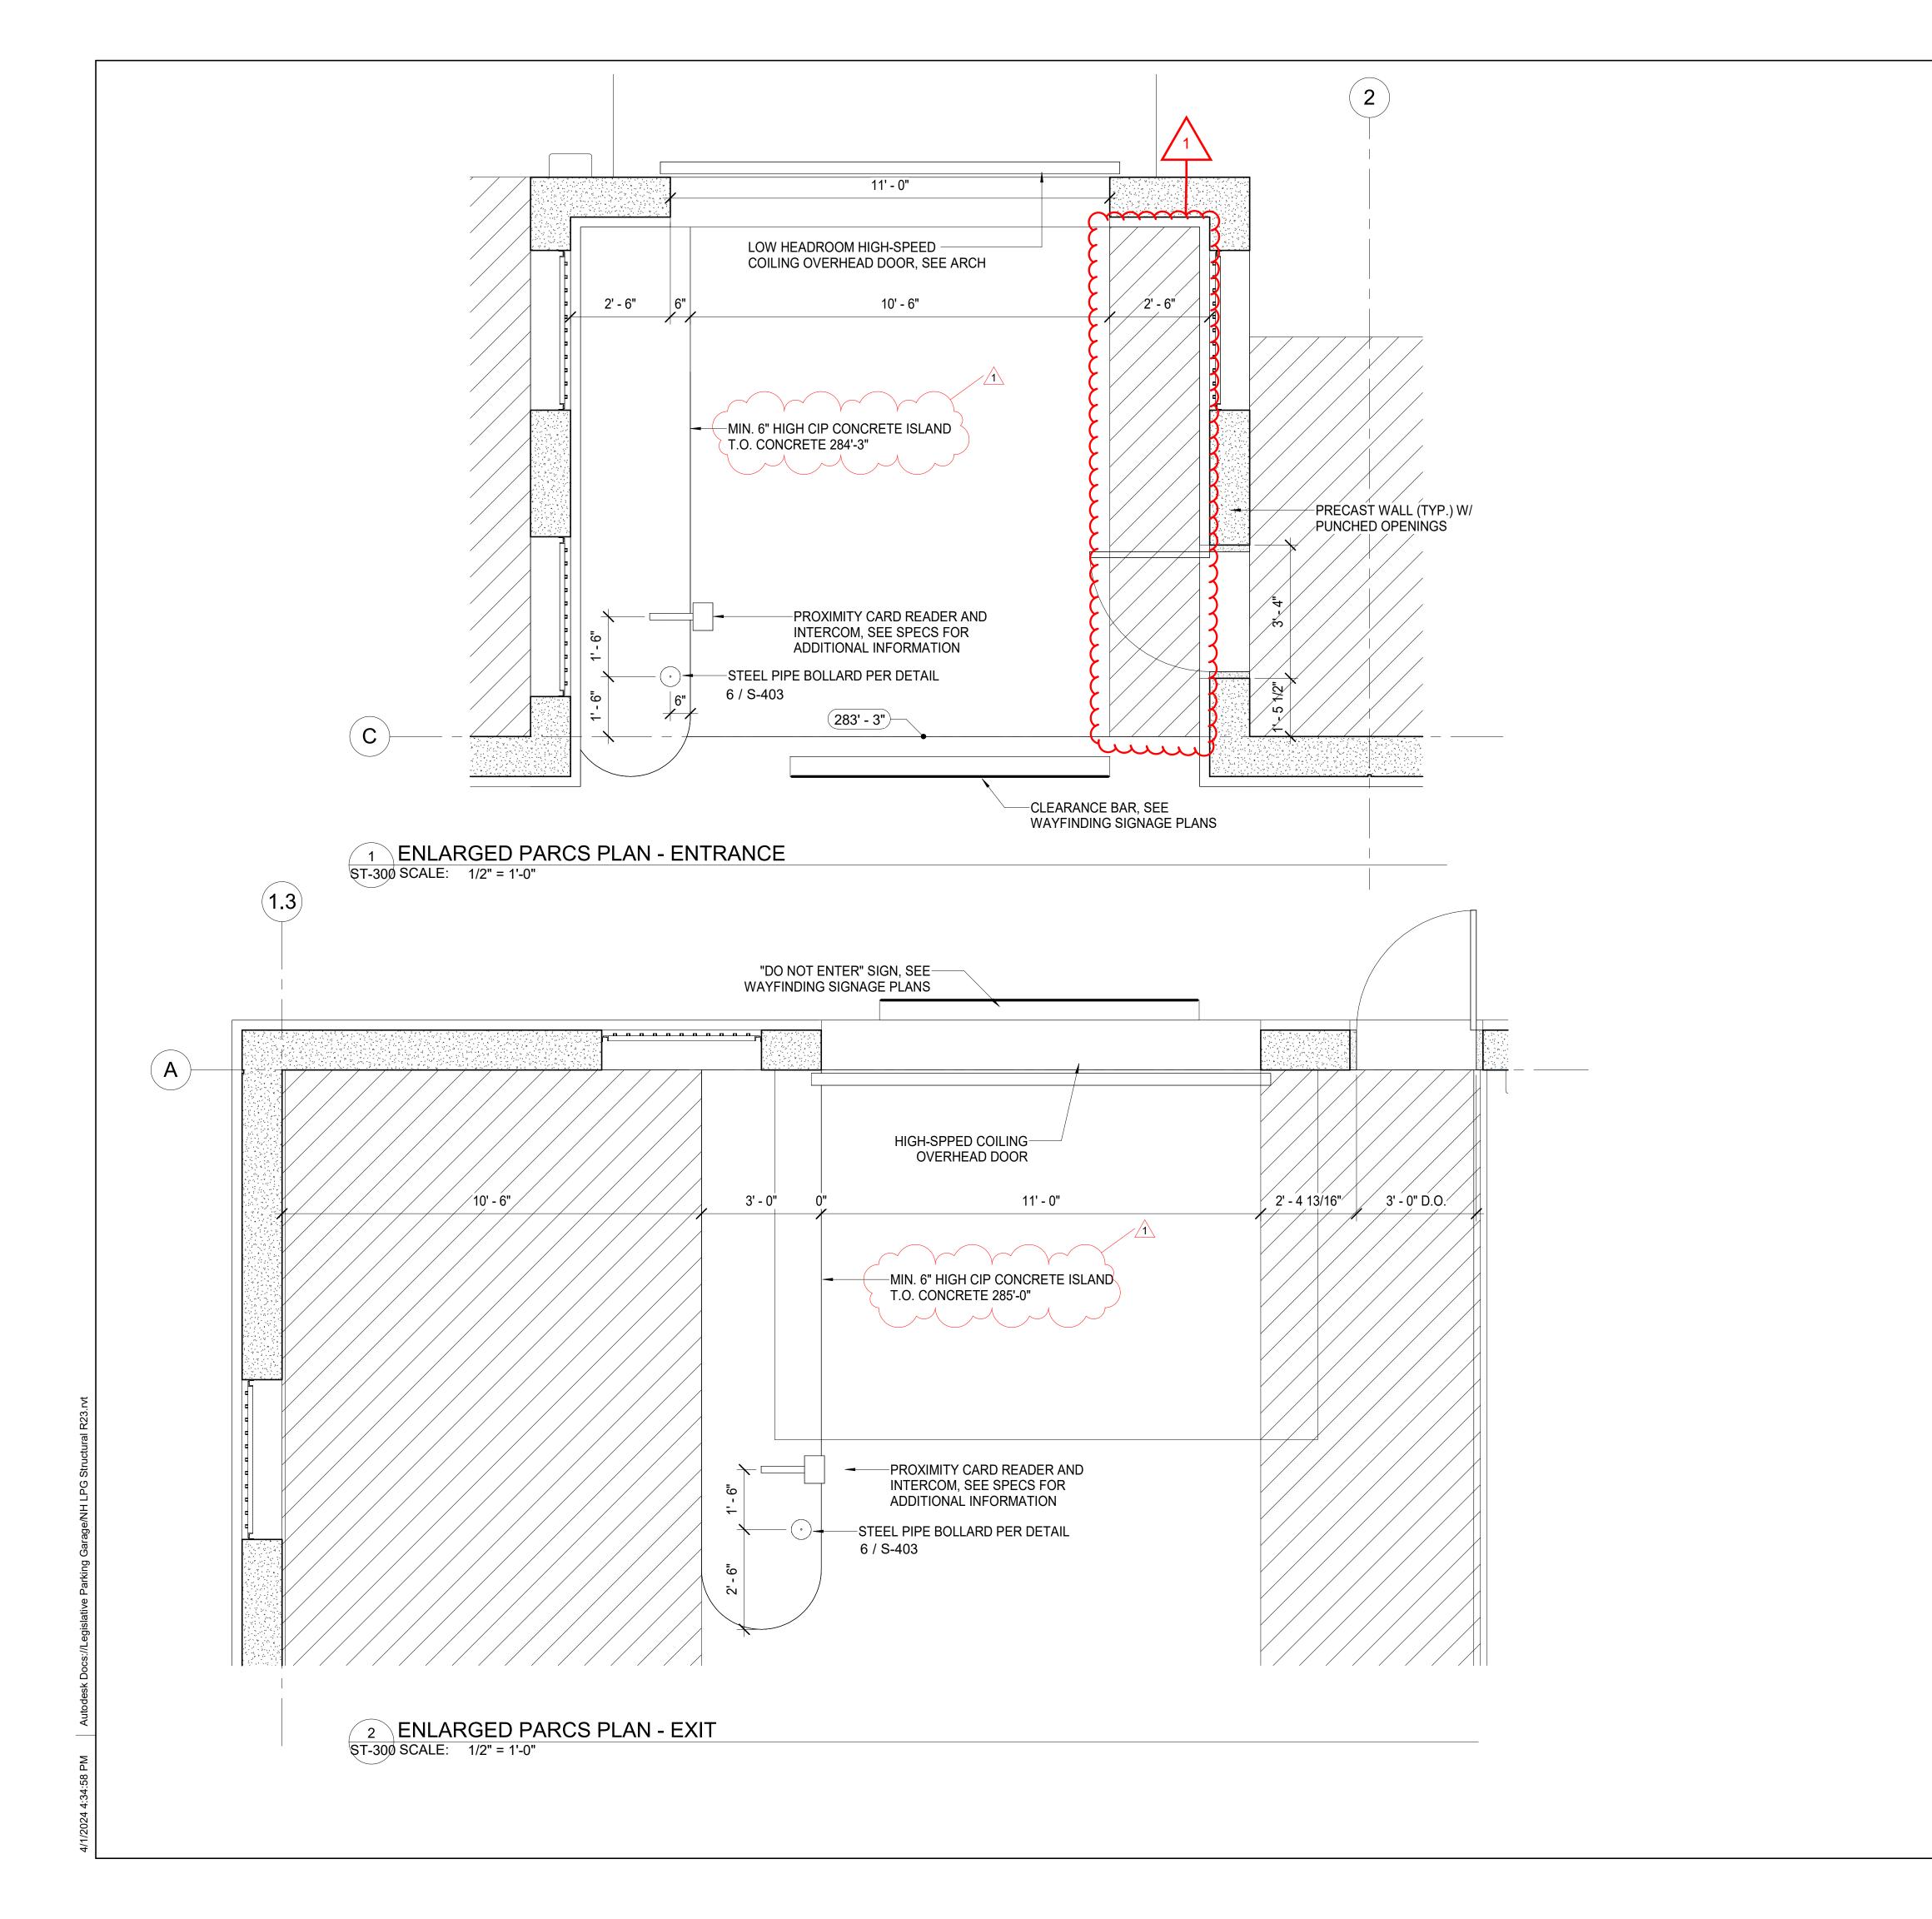
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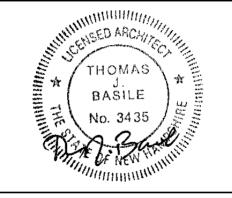
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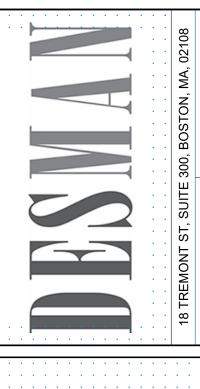
sheet no.

S-114







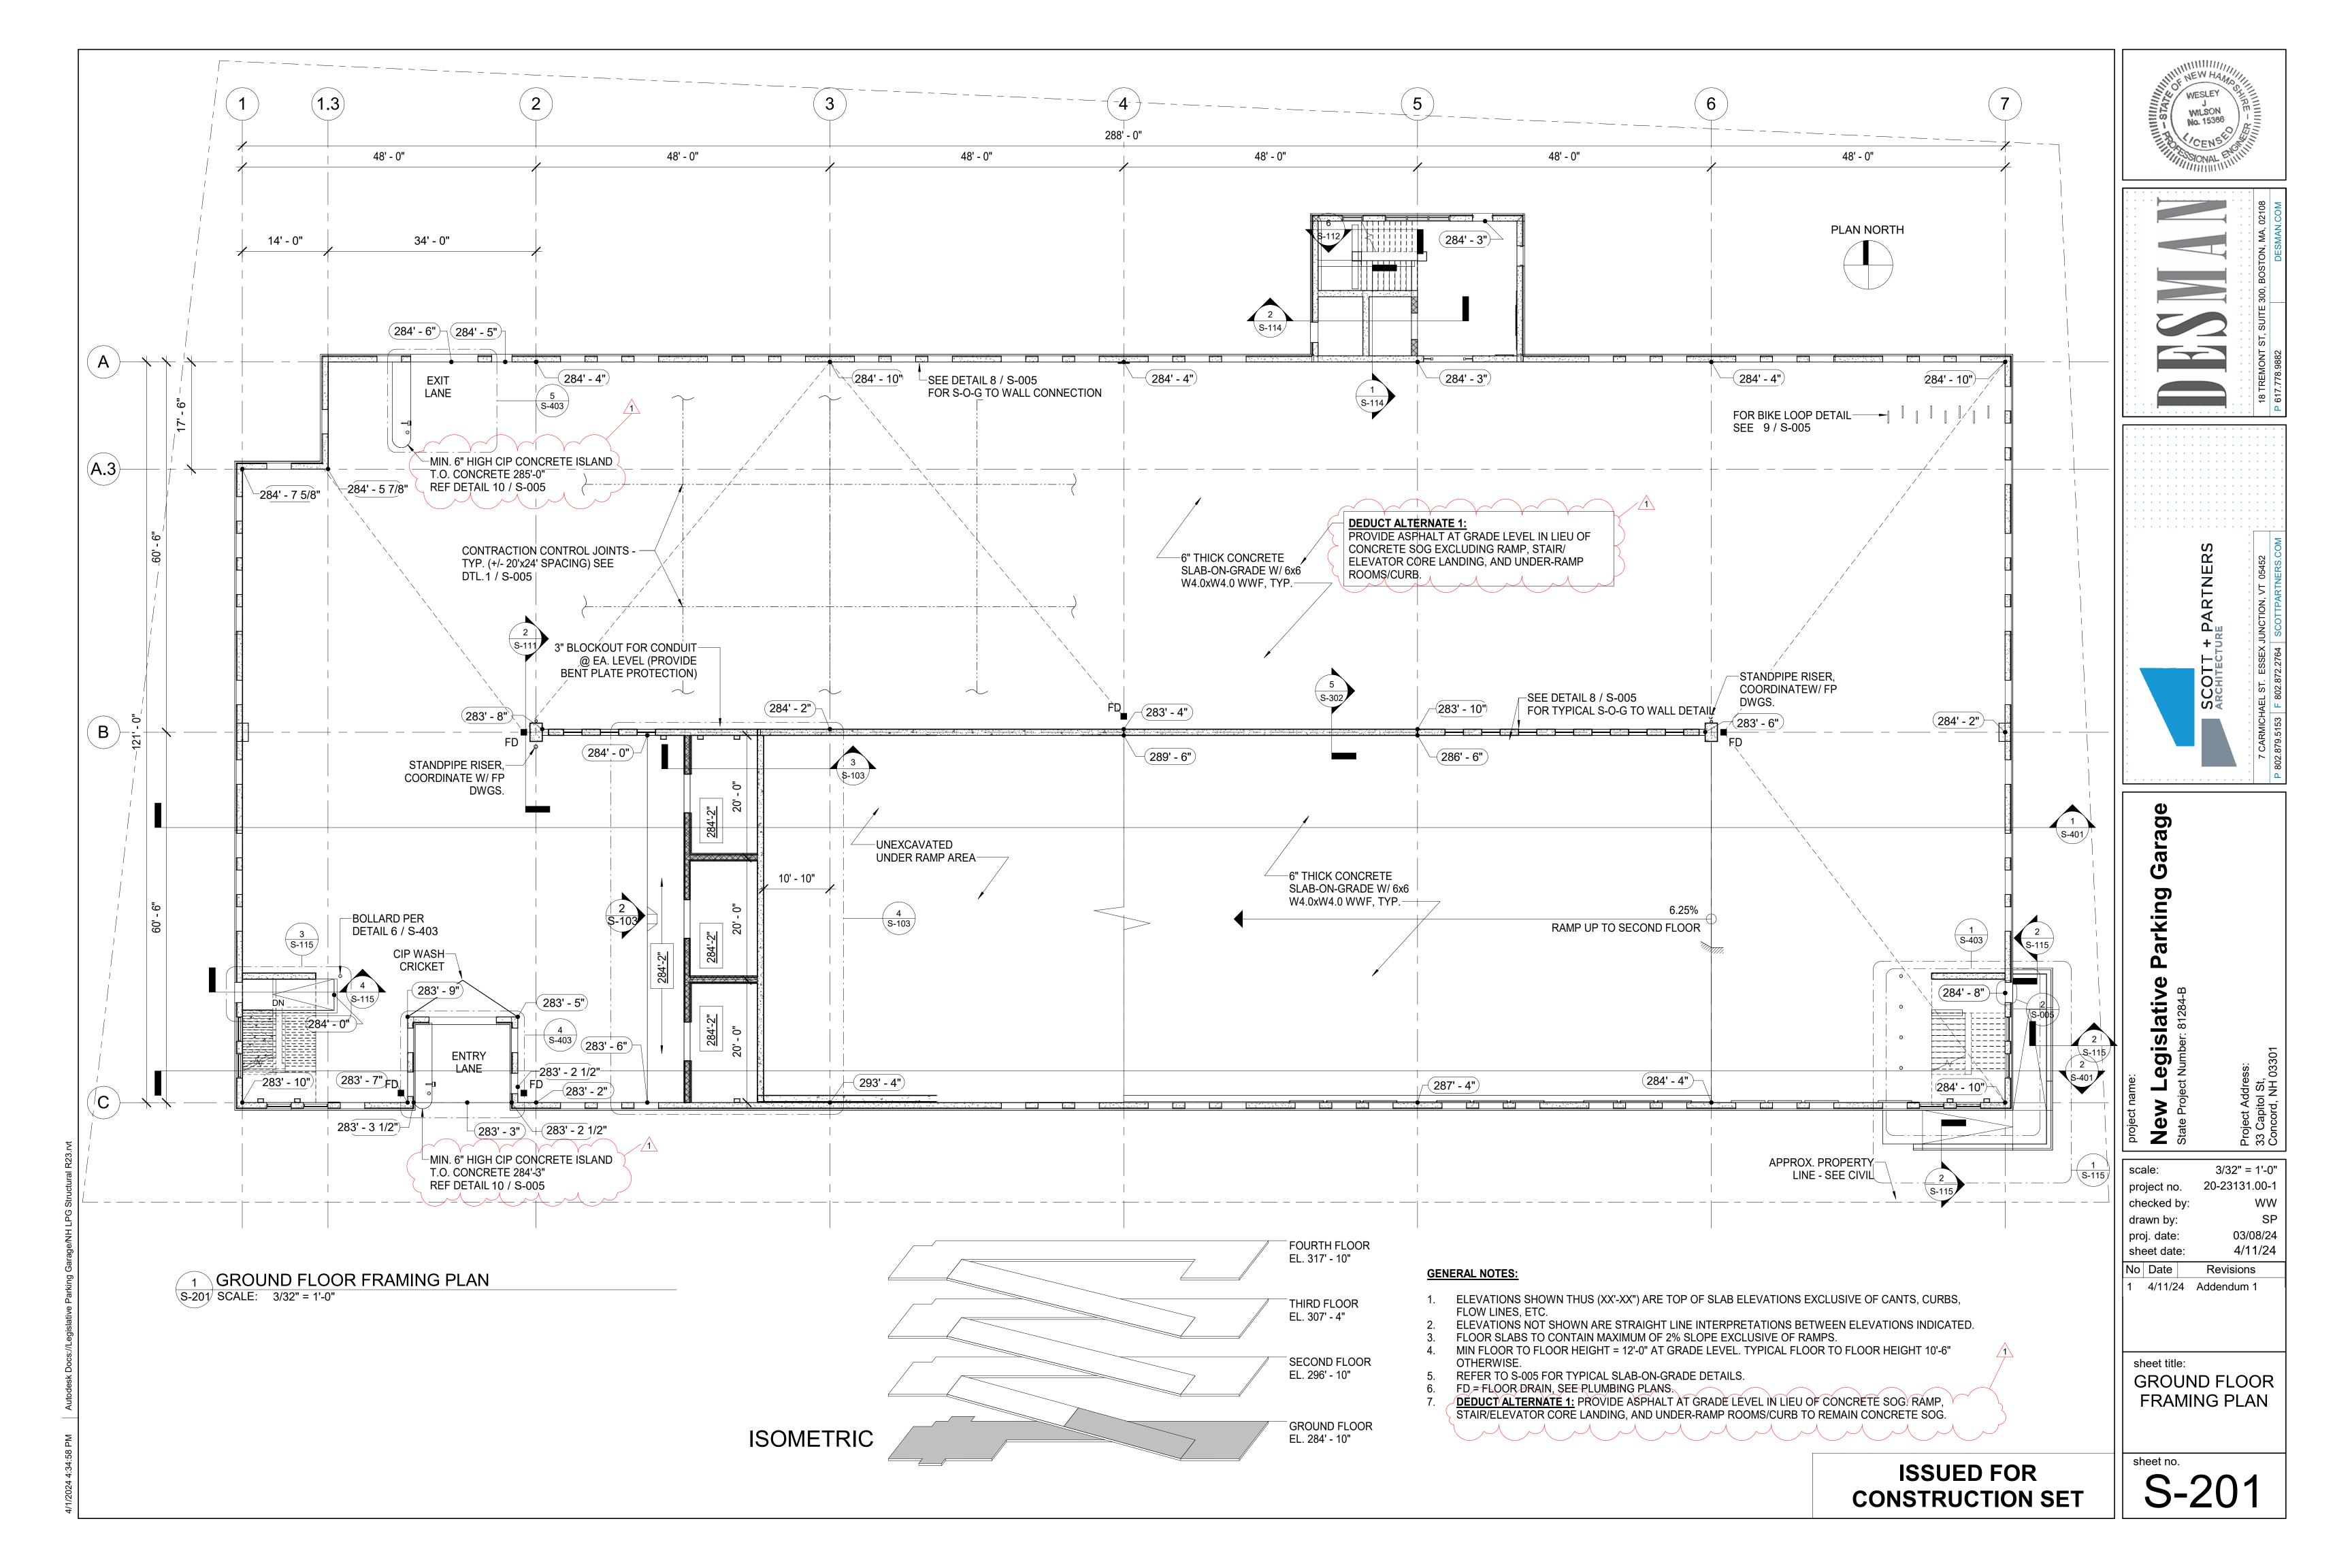

SCOTT + PARTNERS

ARCHITECTURE

7 CARMICHAEL ST. ESSEX JUNCTION, VT 05452

New Legislative Parking Garage
State Project Number: 81284-B
Project Address:
33 Capitol St,
Concord, NH 03301

 scale:
 1/2" = 1'-0"

 project no.
 20-23131.00-1

 checked by:
 WW

 drawn by:
 SP

 proj. date:
 03/08/24

 sheet date:
 4/11/24

 No Date
 Revisions


No Date Revisions

1 4/11/24 Addendum 1


sheet title:
ENLARGED
PARKING ACCESS
& REVENUE
CONTROL PLANS

ISSUED FOR CONSTRUCTION SET

sheet no.
ST-300

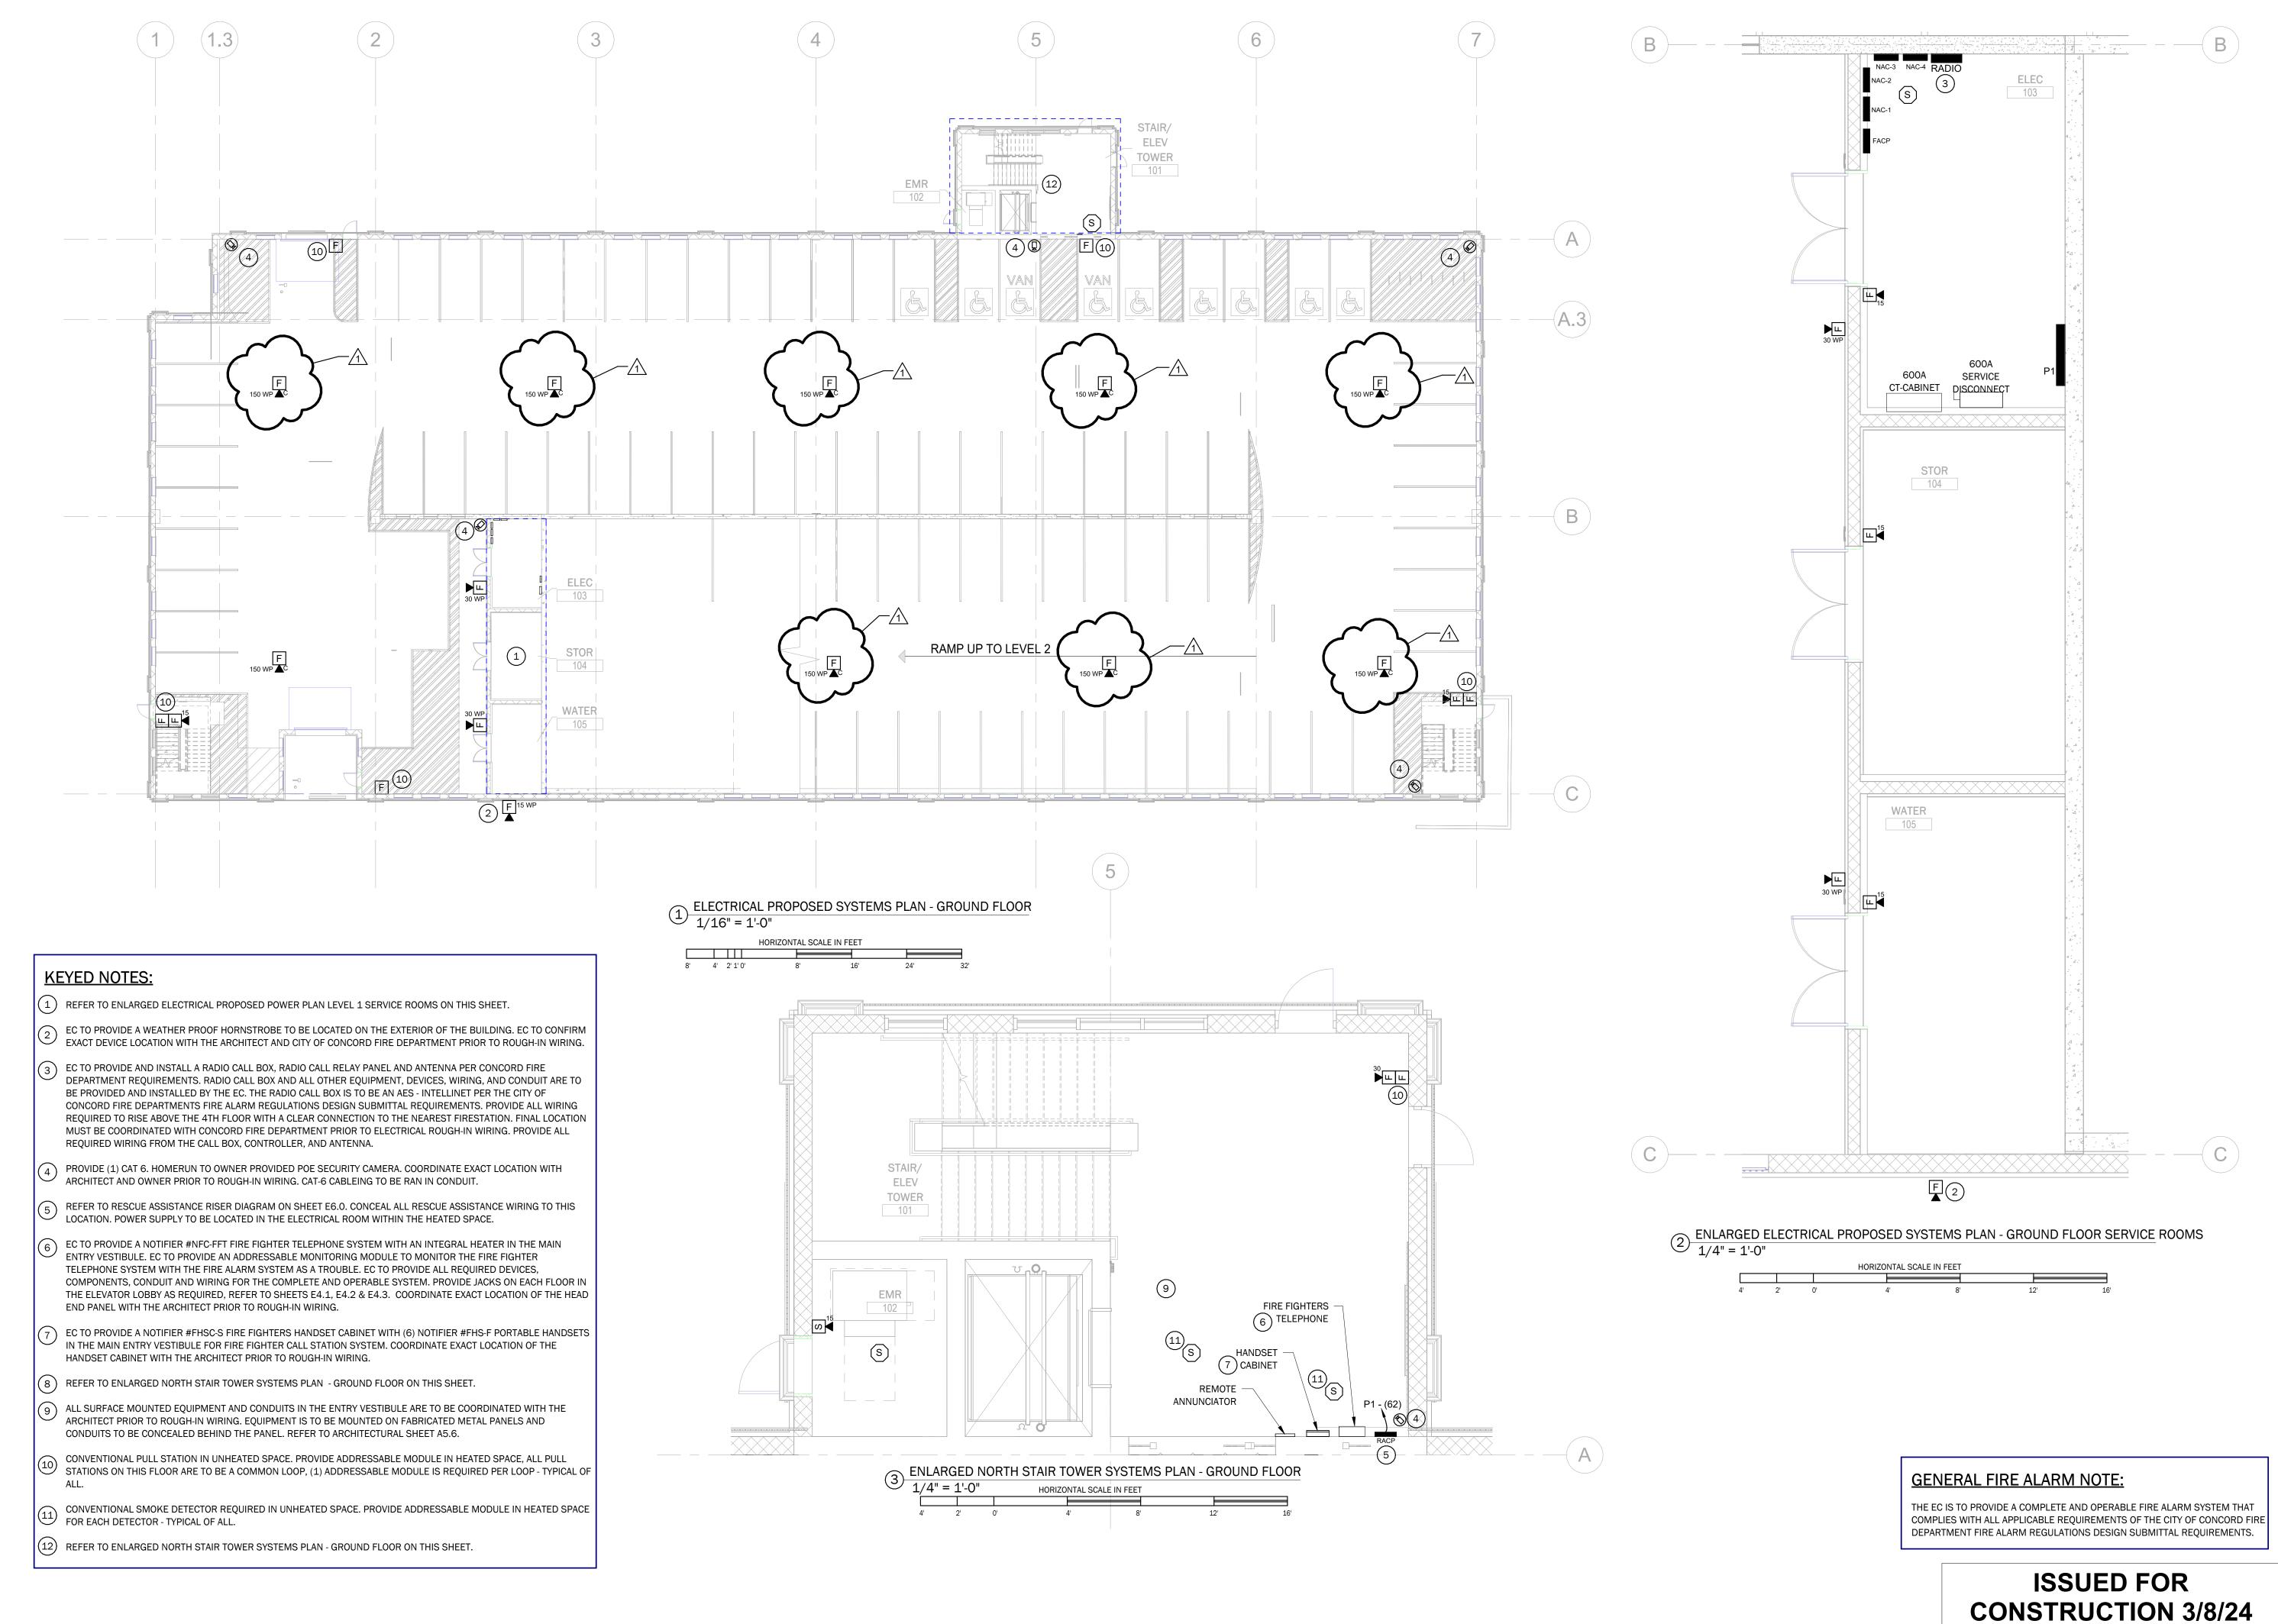

GOULD WAR

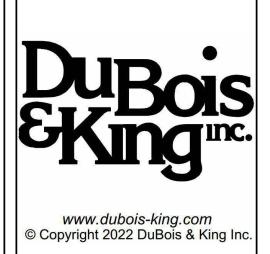

SCOTT + PARTNERS
7 CARMICHAEL ST. ESSEX JUNCTION, VT 05452

NEW LEGISLATIVE PARKING
GARAGE

project address:
33 CAPITOL ST. CONCORD, NH 03301

scale: As indicated project no. 429099 checked by: ASG drawn by: JAFS proj. date: 3/8/24 sheet date: 4/11/24

No Date Revisions

1 4/11/24 Addendum 1


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ELECTRICAL

PROPOSED


SYSTEMS PLAN
GROUND FLOOR

E4.0

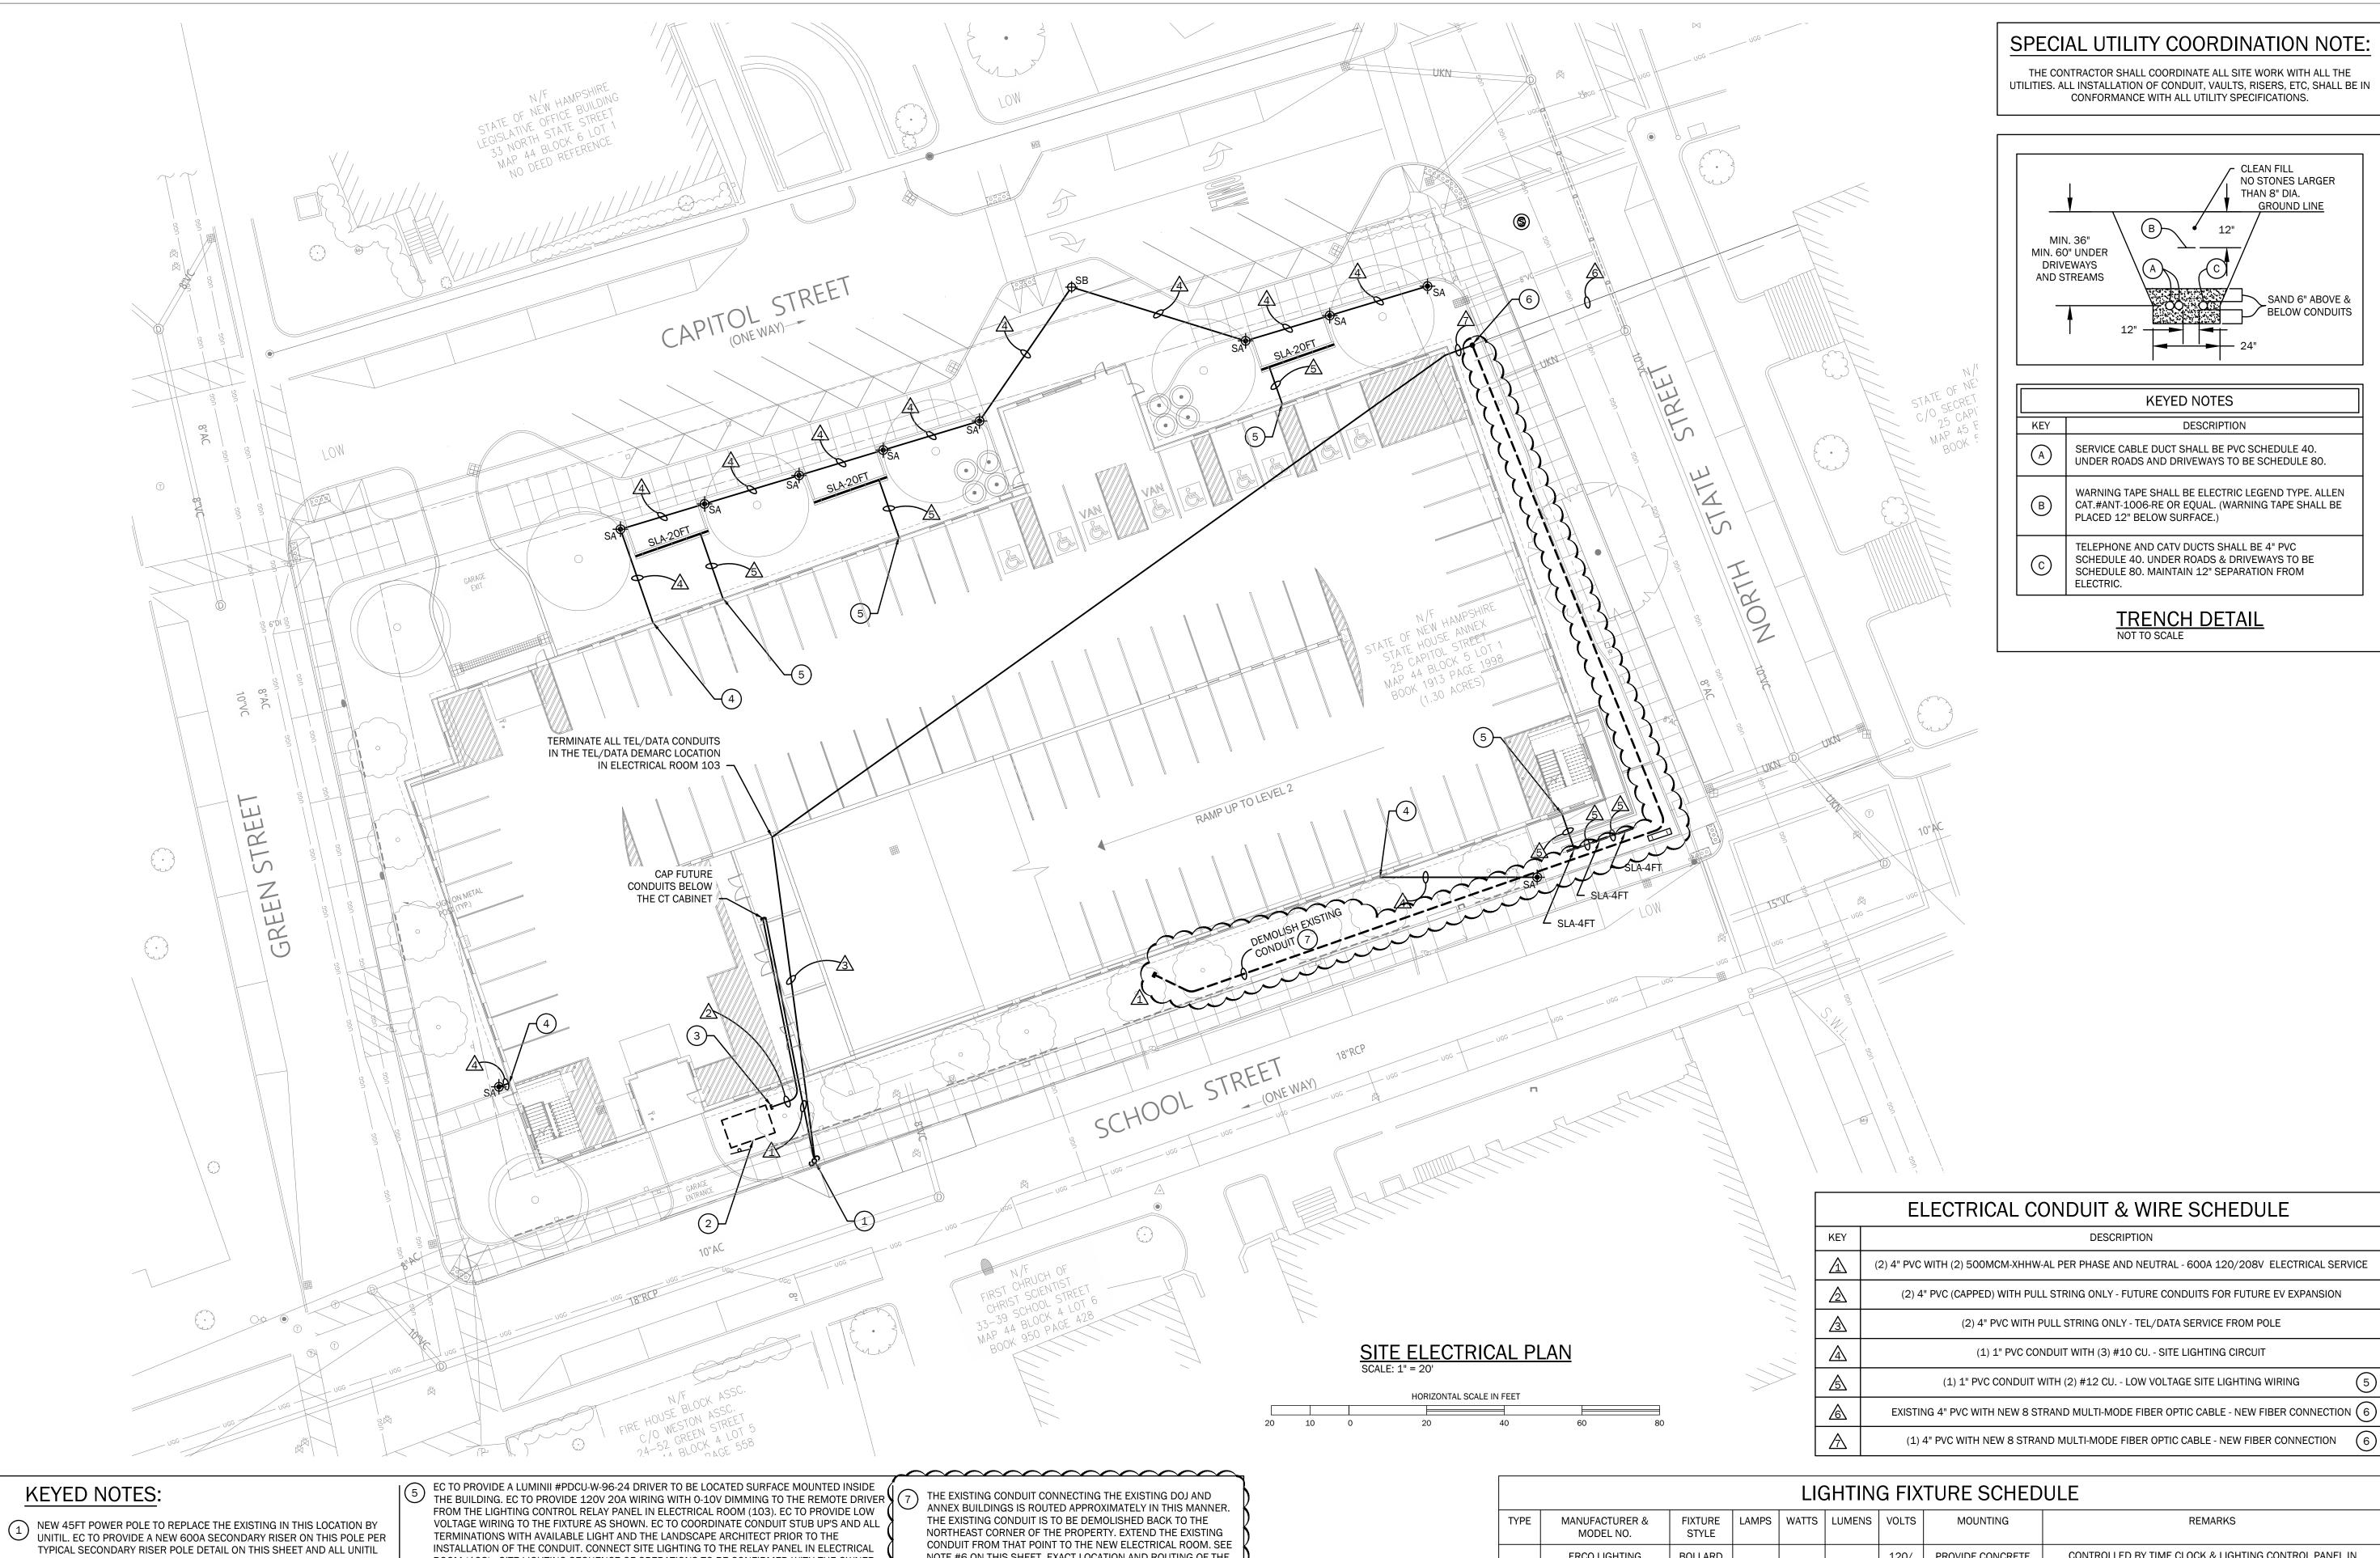

SPECIAL UTILITY COORDINATION NOTE:

THE CONTRACTOR SHALL COORDINATE ALL SITE WORK WITH ALL THE UTILITIES. ALL INSTALLATION OF CONDUIT, VAULTS, RISERS, ETC, SHALL BE IN CONFORMANCE WITH ALL UTILITY SPECIFICATIONS.

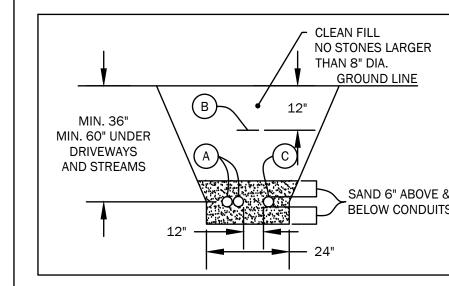

		KEYED NOTES
	KEY	DESCRIPTION
	A	SERVICE CABLE DUCT SHALL BE PVC SCHEDULE 40. UNDER ROADS AND DRIVEWAYS TO BE SCHEDULE 80.
	В	WARNING TAPE SHALL BE ELECTRIC LEGEND TYPE. ALLEN CAT.#ANT-1006-RE OR EQUAL. (WARNING TAPE SHALL BE PLACED 12" BELOW SURFACE.)
	0	TELEPHONE AND CATV DUCTS SHALL BE 4" PVC SCHEDULE 40. UNDER ROADS & DRIVEWAYS TO BE SCHEDULE 80. MAINTAIN 12" SEPARATION FROM

TRENCH DETAIL
NOT TO SCALE

ELECTRICAL CONDUIT & WIRE SCHEDULE DESCRIPTION (2) 4" PVC WITH (2) 500MCM-XHHW-AL PER PHASE AND NEUTRAL - 600A 120/208V ELECTRICAL SERVICE (2) 4" PVC (CAPPED) WITH PULL STRING ONLY - FUTURE CONDUITS FOR FUTURE EV EXPANSION (2) 4" PVC WITH PULL STRING ONLY - TEL/DATA SERVICE FROM POLE (1) 1" PVC CONDUIT WITH (3) #10 CU. - SITE LIGHTING CIRCUIT

(1) 1" PVC CONDUIT WITH (2) #12 CU. - LOW VOLTAGE SITE LIGHTING WIRING EXISTING 4" PVC WITH NEW 8 STRAND MULTI-MODE FIBER OPTIC CABLE - NEW FIBER CONNECTION (6)


- STANDARDS AND REQUIREMENTS.
- APPROXIMATE LOCATION FOR FUTURE PAD MOUNTED UNITIL TRANSFORMER TO FEED FUTURE 1200A SERVICE FOR EV CHARGER EXPANSION.
- (3) CAP AND MARK (2) SPARE 4" CONDUITS IN THIS APPROXIMATE LOCATION FOR FUTURE EV CHARGER EXPANSION. COORDINATE EXACT LOCATION TO CAP THE CONDUITS WITH THE OWNER ARCHITECT AND CIVIL ENGINEER.
- PROVIDE 120VAC, 20A AND 0-10V DIMMING WIRING TO ALL TYPE SA & SB FIXTURES AS SHOWN. CONNECT SITE LIGHTING TO THE RELAY PANEL IN ELECTRICAL ROOM (103). SITE LIGHTING SEQUENCE OF OPERATIONS TO BE CONFIRMED WITH THE OWNER, ARCHITECT AND ELECTRICAL ENGINEER DURING THE LIGHTING CONTROL COMMISSIONING PROCESS.
- ROOM (103). SITE LIGHTING SEQUENCE OF OPERATIONS TO BE CONFIRMED WITH THE OWNER, ARCHITECT AND ELECTRICAL ENGINEER DURING THE LIGHTING CONTROL COMMISSIONING PROCESS.
- THE EXISTING CONDUIT FOR FIBER OPTIC CONNECTION BETWEEN THE EXISTING DOJ BUILDING AND THE STATE HOUSE ANNEX BUILDING IS TO BE DEMOLISHED BACK TO THIS APPROXIMATE LOCATION. EC TO EXTEND THE EXISTING 4" CONDUIT FROM THIS APPROXIMATE LOCATION TO THE MULTI-MODE FIBER OPTIC CABLE FROM THE EXISTING ANNEX BUILDING TO THE NEW PARKING GARAGE. EC TO COORDINATE ALL WORK WITH STATE OF NH I.T. DEPARTMENT PRIOR TO INSTALLATION. EC TO FIELD COORDINATE EXACT LOCATION OF ANNEX BUILDING IT ROOM DURING CONSTRUCTION, PROVIDE PRICING FOR A 450FT RUN OF NEW FIBER OPTIC CABLE. EC TO CONFIRM EXACT LOCATION FOR EXISTING CONDUIT TO BE CUT BACK TO AND CAPPED WITH KEITH HEMINGWAY - STATE OF NEW HAMPSHIRE
- NOTE #6 ON THIS SHEET. EXACT LOCATION AND ROUTING OF THE OF THE EXISTING CONDUIT IS TO BE BACK TO A SAFE LOCATION TO AVOID DAMAGE DURING CONSTRUCTION.

				LIC	יאוווחג	G FIX	TURE SCHED	ULE
TYPE	MANUFACTURER & MODEL NO.	FIXTURE STYLE	LAMPS	WATTS	LUMENS	VOLTS	MOUNTING	REMARKS
SA	ERCO LIGHTING 35748.023	BOLLARD LIGHT	LED	14	1260	120/ 277	PROVIDE CONCRETE BOLLARD BASE	CONTROLLED BY TIME CLOCK & LIGHTING CONTROL PANEL IN ELECTRICAL ROOM (103) REFER TO KEYED NOTE #4 ON THIS SHEET
SB	BEGA LIGHTING 99556	POLE LIGHT	LED	40	4555	120/ 277	POLE MOUNTED 10FT AFG	CONTROLLED BY TIME CLOCK & LIGHTING CONTROL PANEL IN ELECTRICAL ROOM (103) REFER TO KEYED NOTE #4 ON THIS SHEET
SLA	LUMINIL LIGHTING BOSW-xx-HE48LO-30K-F	SURFACE	LED	1.9 W/FT	125 L/FT	24 VDC	RECESSED IN BENCH	CONTROLLED BY TIME CLOCK & LIGHTING CONTROL PANEL IN ELECTRICAL ROOM (103) REFER TO KEYED NOTE #4 ON THIS SHEET

1.) PROVIDE THE TYPE SB POLE MOUNT FIXTURE WITH A BEGA LIGHTING #10-RFNS1. LANDSCAPE ARCHITECT TO SELECT POLE FINISH, AND BASE COVER. COORDINATE EXACT REQUIREMENTS WITH THE LANDSCAPE ARCHITECT

2.) ALL EXTERIOR LIGHTING SELECTIONS/SPECIFICATIONS ARE BY AVAILABLE LIGHT COORDINATE EXACT REQUIREMENTS WITH AVAILABLE LIGHTING LIGHTING DESIGN PLANS.

ISSUED FOR CONSTRUCTION 3/8/24

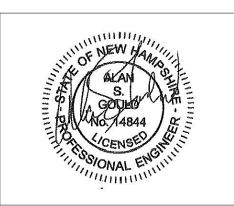



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AS NOTED scale: project no. checked by: drawn by: proj. date: 4/11/24 sheet date:

No Date Revisions 4/11/24 Addendum 1

sheet title:

SITE **ELECTRICAL** PLAN

SE1.0

FOR SITE VISITATION TO BPW #81284-B

New Legislative Parking Garage 04/09/2024 AT 09:30 am

Harry	Marke McLaughlio
COMPANY NAME	YOUR NAME (PLEASE PRINT)
16 Harvey ROAD	Mar hi
ADDRESS	SIGNATURE
Bestoro NH	Mulsughlis elecution
	E-MAIL
403-624-4600	
PHONE	FAX
	=======================================
, /	
HOURY	I'm Cottechand
COMPANY NAME	YOUR NAME (PLEASE PRINT)
10 Harvex Bd	A (- 1)
ADDRESS	SIGNATURE 1 / /
Beford NH 03/10	- Hotterhand @hecnh.com
	E-MAIL
603 85/ 0128	
PHONE	FAX
1 2 1 0 11	
Noonan Brother Paintin	Stelhen Zarakotar
Noonan Brother Painting	Stelhen Zarakotas YOUR NAME (PLEASE PRINT)
Noonan Brother Painting COMPANY NAME 140 Boxchard St	Stelhen Zarakotas YOUR NAME (PLEASE PRINT)
140 Boxhard St ADDRESS	YOUR NAME (PLEASE PRINT)
140 Boxhard St ADDRESS	YOUR NAME (PLEASE PRINT)
ADDRESS MANCHETER NA 03/03	YOUR NAME (PLEASE PRINT) SIGNATURE GULL F-MAII
140 Boxhard St ADDRESS	YOUR NAME (PLEASE PRINT) SIGNATURE GULL F-MAII
ADDRESS MANCHETER NA 03/03	YOUR NAME (PLEASE PRINT)
COMPANY NAME 140 Boxchard St ADDRESS MANCHYLLY NH 03103 603-621-9422	SIGNATURE E-MAIL SHEVE & NOMAN Wother painty net
COMPANY NAME 140 Boxchard St ADDRESS MANCHYLLY NH 03103 603-621-9422	SIGNATURE E-MAIL Steve@ Noman wother painty net FAX
COMPANY NAME 140 Boxchard St ADDRESS MANCHYLLY NH 03103 603-621-9422	SIGNATURE E-MAIL Steve@ Noman wother painty net FAX
ADDRESS MANCHYSLY NH 07107 603-621-9922 PHONE COMPANY NAME	SIGNATURE E-MAIL Steve Noman wother painty net FAX
COMPANY NAME 140 Boxchard St ADDRESS MANCHESTRY NAL 03/03 603-621-9422 PHONE	SIGNATURE E-MAIL Heve Noman wother painty Met FAX YOUR NAME (PLEASE PRINT) SIGNATURE
COMPANY NAME 140 BUCHERS ADDRESS MANCHYSKY NH 07107 603-621-9422 PHONE COMPANY NAME 310 TURNOR Rd	SIGNATURE E-MAIL Heve Noman wother painty Met FAX YOUR NAME (PLEASE PRINT) SIGNATURE
COMPANY NAME 140 Bachard St ADDRESS MANCHYLLY NAL 03/07 603-621-9422 PHONE COMPANY NAME 310 TURAPIK Rd ADDRESS NEW IPSWICH NH	SIGNATURE E-MAIL Heve Noman wother painty Met FAX Adam Seppak YOUR NAME (PLEASE PRINT)
COMPANY NAME 140 BOXCHOLD ST ADDRESS MANCHYLLY NAL 07/07 603-621-9422 PHONE Hotter COMPANY NAME 310 Tompike Rd ADDRESS	SIGNATURE E-MAIL SHEVE NOMAN WOTHER PAINTY MET FAX Adam Seppek YOUR NAME (PLEASE PRINT) SIGNATURE A Seppek @ Hutter Construction . Con

FOR SITE VISITATION TO BPW #81284-B New Legislative Parking Garage 04/09/2024 AT 09:30 am

NOITH AYANCH	JAMES SCHWARTZHOAF
COMPANY NAME	YOUR NAME (PLEASE PRINT)
76 OD TURNAHERA	A COLOR
ADDRESS	SIGNATURE
CON COPED	JSCHWARTSHARF @ WORTH GRANCH, WEY
900 0000	E-MAIL
603-345-5359	B-111/218
PHONE	FAX
PHONE	FAA
$n \cup A = 1$	- 4 1 I
Dailey Pre Cast COMPANY NAME	11mothy Made
COMPANY NAME	YOUR NAME (PLEASE PRINT)
295 Aurent Rd	Color I
295 Augor & Rd. Address	SIGNATURE
Shofk bury, VT 08262	TANDE Pechhan, Coz
	E-MAIL
860-729-7350	
PHONE	FAX
CTC C	
EJC Engineers	Varier Lugo
COMPANY NAME	YOUR NAME (PLEASE PRINT)
+ emerald //	
MASHUM NH 03062	SIGNATURE
NASPUM NH 03062	Javielszoejc Damail com
	E-MAIL
6027185544	
PHONE	FAX
PHONE	FAX
PHONE RADIA Skell	FAX
PALA Sheebola	Jan Brookslaste
COMPANY NAME	YOUR NAME (PLEASE PRINT)
COMPANY NAME TO PLANDENE	YOUR NAME (PLEASE PRINT)
COMPANY NAME ADDRESS	YOUR NAME (PLEASE PRINT) SIGNATURE
COMPANY NAME TO PLANDENE	YOUR NAME (PLEASE PRINT) SIGNATURE MARKING MARKETICA,
COMPANY NAME ADDRESS Washan My 57865	YOUR NAME (PLEASE PRINT) SIGNATURE
COMPANY NAME ADDRESS	YOUR NAME (PLEASE PRINT) SIGNATURE MARKING MARKETICA,

FOR SITE VISITATION TO BPW #81284-B

New Legislative Parking Garage

04/09/2024 AT 09:30 am

Dec	1° 2 1
F C Cay SMUCTICA	Um soule
COMPANY NAME	YOUR NAME (PLEASE PRINT)
193 Tilley Dr.	Jen Eouro
S. Bulling on V	SIGNATURE EDCCARSTRUCTUM, COM
~~	E-MAIL
802-598-3072	
PHONE	FAX
Kevin toresself Exc //c COMPANY NAME	Kevin Jorgsse H
COMPANY NAME	YOUR NAME (PLEASE PRINT)
75 Merrinack od	Muguer
ADDRESS	SIGNATURE
Amherst WH 03031	KJG-EXCOHOL. COM
(22 -22 1162	E-MAIL
603-673-1483	603-673-1483
PHONE	FAX
1100000	1 60/
F L Menill Construction	YOUR NAME (PLEASE/PRINT)
COMPANY NAME	YOUR NAME (PLEASE/PRINT)
35 Veterans DV	
ADDRESS NH 03367	TM Gormack @ Flmerrill. Lon
Lordon NH 03367	E-MAIL
603 234 2629	603 228 5559
PHONE	FAX
Johnson and Jordon	Shave Foddon
COMPANY NAME	YOUR NAME (PLEASE PRINT)
ADDRESS 1 1 2 11	SIGNATURE
12 / 1/1/1	O SIGNATURE
De (won o III (T	Stadden @ Tshuson and Tonday con
603-724-1539	

FOR SITE VISITATION TO BPW #81284-B New Legislative Parking Garage 04/09/2024 AT 09:30 am

ABGRIHAW CONST INC	AUGK NUNES
COMPANY NAME	YOUR NAME (PLEASE PRINT)
ADDRESS	SIGNATURE
LOWELL, MA 01854	alex nunere aberthauccion
-	E-MAIL
978-710-0003	
PHONE	FAX
COMPANY NAME	YOUR NAME (PLEASE PRINT)
ADDRESS	SIGNATURE
	E-MAIL
PHONE	FAX
COMPANY NAME	YOUR NAME (PLEASE PRINT)
ADDRESS	SIGNATURE
	E-MAIL
	E-MAIL
PHONE	
	FAX
	FAX
COMPANY NAME	
COMPANY NAME	YOUR NAME (PLEASE PRINT)
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COMPANY NAME	YOUR NAME (PLEASE PRINT)